

"SOARING ABOVE YOUR EXPECTATIONS"





Table of Contents

COMPANY PROFILE

Our Mission Who We Are

MANAGEMENT PLAN

DRAWINGS

Working Drawings

ESTIMATE

Material & Labor Estimate
Finish Materials **Price Sheets**

SCHEDULE

MISCELLANEOUS

Honor Pledge Similar Homes





"SOARING ABOVE YOUR EXPECTATIONS"

COMPANY PROFILE





December 2023

Student Chapter
National Association of Home Builders
NAHB Student Competition
Re: Bid proposal for management project & proposal
Velvaera, a Magleby Development
Park City, Utah

Dear Members of the Judging Panel:

Apex Contractors is excited to announce its design/estimating bid for the proposed National Association of Home Builders project in Park City, Utah.

Apex Contractors offers a variety of advantages that other companies can't match. We work with various NDSCS programs such as the Electrical Technology and the HVACR Technology to assemble allowances for the specific estimate. Our company ensures every part of the construction process under one roof which allows us to have direct communication with our whole team.

On September 2023, Apex Contractors reviewed the packet of documents and began to split the team up into three parts. As a team, we discussed and worked effectively to review the project scope to get an understanding of what needs to be done for this project. We then divided the project into three categories and started the work.

The three part categories helped us to work efficiently and to conduct work in an orderly time fashion. With the help from industry professionals such as our local HBA, and the NDSCS program instructors.

In conclusion, we have provided a complete set of working drawings, a labor/materials estimate, and a construction schedule. We gained real-world work experience and got an overall scope into the professional industry world.

Thank you for the opportunity to present our proposal. Any questions that you have can be answered during our presentation time.

Sincerely, NDSCS's Apex Contractors





Who Are We?



Glen Erickson

3rd Year Construction Management Student Lead Estimator

Logan Prochnow

3rd Year Construction Management Student

Project Manager









Emily Schmidt

2nd Year Architectural Modeling & Design

Drafter

David Hartung

2nd Year Architectural Modeling & Design

Drafter









Mikaela Prochnow

1st Year Architectural Modeling & Design

Assistant Drafter

Chloe Lawrence

1st Year Architectural Modeling & Design

Design Assistant







"SOARING ABOVE YOUR EXPECTATIONS"

MANAGEMENTPLAN





Construction Management Plan:

Trade Partner Selection --

- Apex Contractors will select a certified contractor based on certain qualities that best match our companies' morals and values. Our trade partner selection will be based on these key things:
 - Safety procedures & history
 - Past Projects & Performance Ratings
 - Company Reputation & Culture
 - Communication
 - o Adequate Staffing, Manpower, and Equipment (Quality Personnel)
- Once the above requirements are considered, the Trade Partner Selection process will then be awarded to the lowest bid. ALL requirements must be met to receive a valid contract, if not, the next lowest bidder and certified contractor will be selected.

Material Procurement & Management --

- Materials will be delivered to Jobsite in accordance with the progress of the building.
- Once delivered, they will be sorted by the Apex Contractors field crew into piles, keeping in mind the order of installation.
 - ALL items will be stored outside. Materials will have the ability to be tarped to maintain quality of product and shield weather acts like rain, etc.
- Refer to schedule for information on when to order material
 - Material should be delivered one week before estimated installation but no earlier than
 3 weeks before install.
- All material handling will be documented to ensure accuracy of delivery and bookkeeping.
- Material Delivery will be documented with a checklist -
 - Item checklist points will include:
 - Date Delivered
 - What company delivered the material? Name of driver?
 - Quality assurance (Make sure material is in premium condition and that it's the correct material/dimension)
 - Picture taken of delivered material.
 - Quantity Check



^{*} All invoices of delivered material will be scanned and placed into a digital & hard copy filing systems*



Building Inspections --

- Building inspections will be coordinated as trades are being installed.
- Inspections will be documented by the lead superintendent and placed into the filing system.
 - o Date Conducted
 - Inspection Agency
 - O What was inspected? Who was the inspector?
 - o Inspection Reports signed, sealed, and noted if passed or failed.
- Required trades to be inspected per Utah Building Code (2021 IBC):
 - Footing inspection Tentatively (5/2/2024)
 - Foundation inspection Tentatively (5/27/2024)
 - Basement Slab Inspection -- Tentatively (7/2/2024)
 - Underground inspection -- Tentatively (6/28/2024)
 - Framing inspection -- Tentatively (10/15/2024)
 - Utility Rough-Ins (Plumbing, Mechanical, Electrical, etc) Tentatively (10/15/2024)
 - Vapor Barrier Inspection Tentatively (10/24/2024)
 - Special inspections Tentatively (1/7/2024)
 - Final inspection -- Tentatively (1/7/2024)


SWPPP & Site Logistics Plan:

- Silt fence to be installed around site
- When sitework is completed, a 1% slope towards silt fence
- Finish Grade shall slope a minimum of 6 inches in the first 10 feet away from the building
- To increase security, cameras will be present on site
- After weather conditions occur during construction, documentation will take place in an excel spreadsheet to keep accurate records of site conditions. Items to be documented will include:
 - Date Weather Occurred
 - Amount of Precipitation
 - Signature of Inspector



^{*}Framing inspections cannot happen until have Electrical and Mechanical Rough-Ins are completed*



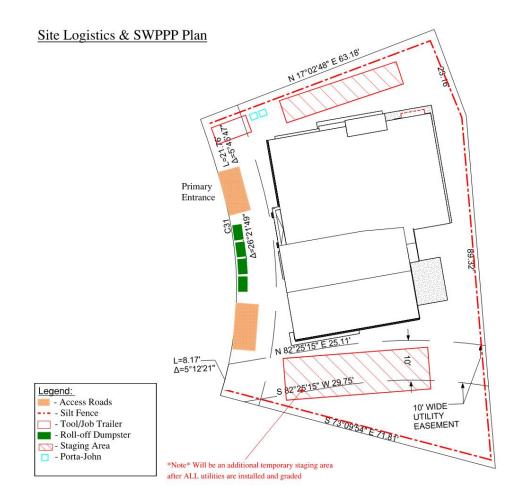





<u>Implementation of Sustainable features:</u>

- Divert recyclable items from landfill
- Haul Concrete waste to a crushing site
- 3 10-yard dumpsters will always be on site, for recycling purposes
 - o Dumpster Uses Metal, Wood, & Common construction waste
- Nightly site walkthroughs to ensure lights and power is off
- To reduce material waste, ensure material measurements are correct Measure twice, Cut once
- Main Goal Recycle & Reduce Waste as much as possible

Safety Management Plan:

- Trench boxes used for utility excavation
- Safety Glasses to be worn at all times
- Hard Hats are Mandatory
- High Visibility clothing is required
- Mandatory Morning Safety Meetings
 - o Everyone at meeting required to sign name for documentation of attendance
- Site Safety Supervisor to visit Jobsite once a week
- Contractor required to provide drinking water on site
- OSHA guidelines will be maintained and posted
- Identify Potential Hazards and report them (ex. Defects & Near Misses)
- Inspect equipment before each use
- Have employee training every other week
- ALWAYS maintain proper housekeeping A clean jobsite is a safe jobsite
- First Aid Kits & Fire Extinguishers Readily Available
- All Required Personal Protective Equipment will be provided by Apex Contractors





Safety Signs to be posted:





CONSTRUCTION SITE SAFETY



No Trespassing: **Authorized Personnel Only.**



Children must not enter or play on a job site.



Personal Protective Equipment is mandatory.



Dangerous area: falling objects, trip hazards, electrical hazards, & construction equipment in use.



Safety is a priority

Personal Protective Equipm

- PPE Signage MUST be provided and maintained by employers.

















Head protection

Risks: impact from falling or flying objects, risk of head bumping, hair enlangement. Options: a range of helimets, bump caps, agoshair ness.

Breathing protection

Nisks: dust, repour, gas, oxygen-def etmospheres. Options: disposable filtering face pie or respirator, half-or full-face respirato eir fied helmets, breathing apparatus.

Hearing protection

Hands and arms

Body protection

bishs: temperature extremes, adverse veather, chemical or metal splesh, spray rom pressure lisaks or spray guns, impact ir penetration, contaminated dust. rafis, boter suits, specialist thing, high-visibility clothing

- and the conditions at the we can it be adjusted to fit the weaver cornectly and be comfortable? Has the state of health of the who will be wearing it been taken into consideration?

- Does it prevent or adequately control the risks involved































"SOARING ABOVE YOUR EXPECTATIONS"

DRAWINGS





SHEET LIST					
SHEET#	SHEET NAME				
C001	COVER				
C002	SITE				
G003	BUILDING AREA ANALYSIS				
G004	WALL ASSEMBBLIES				
A 102A	ARCH. FOUNDATION PRESPECTIVES				
A 103	LEVEL 0 FLOOR PLAN				
A 104	LEVEL 1 FLOOR PLAN				
A 105	ROOF PLAN				
A 106	LEVEL 0 CEILING PLAN				
A 107	LEVEL 1 CEILING PLAN				
A 201	EXTERIOR ELEVATIONS				
A 202	EXTERIOR ELEVATIONS				
A 302	BUILDING SECTIONS				
A 504	ROOF DETAILS				
A 603	WINDOW & DOOR SCHEDULE & ELEVATIONS				
S 201	FOUNDATION PLAN & DETAILS				





VALVAERE - CABIN B

Emily Schmidt
David Hartung
Glen Erickson
Logan Prochnow
Chloe Lawrence
Mikaela Prochnow

GOVERNING BUILDING CODES & INFORMATION

BUILDING CODE: 2015 INTERNATIONAL RESIDENTIAL CODE (I.R.C.) MECHANICAL CODE: 2015 INTERNATIONAL MECHANICAL CODE (I.M.C.) WITH UTAH STATE AMENDMENTS FIRE CODE: 2015 INTERNATIONAL FIRE CODE (I.F.C.)

PLUMBING CODE: 2015 INTERNATIONAL PLUMBING CODE (I.P.C.) ENERGY CONSERVATION: 2015 INTERNATIONAL ENERGY CONSERVATION CODE (I.E.C.C.)

ACCESSIBILITY: 2009 ANSI 117.1 & 2015 I.B.C.

OCCUPANCY GROUP: R2 BUILDING TYPE: TYPE V-B FIRE SPRINKLERD: YES FIRE SPRINKLER TYPE: NFPA 13 ADDRESSABLE FIRE ALARM: YES

RISK CATEGORY (I.C. 104.5): II SITE EXPOSURE: B BASIC WIND SPEED: 90 MPH

DEFERRED SUBMITTAL REQUIREMENTS

DEFERRED SUBMITTALS ARE THOSE PORTIONS OF DESIGN THAT ARE NOT SUBMITTED AT THE TIME OF THE PERMIT APPLICATION AND HAVE RECEIVED PRIOR APPROVAL FROM THE BUILDING OFFICIAL TO BE DEFERRED.

THE DEFERRED SUBMITTALS SHALL BE SUBMITTED TO THE ARCHITECT AND GENERAL CONTRACTOR WITHIN SIX WEEKS TO COMMMENCEMENT OF CONSTRUCTION TO THIS PORTION OF WORK.

RRED SUBMITTAL PROCESS:

- THE DEFERRED SUBMITTAL SHALL FIRST BE REVIEWED BY THE GENERAL CONTRACTOR FOR COMPLIANCE WITH THE CONSTRUCTION DOCUMENTS. THE SUBMITTAL MUST BE REVIEWED, APPROVED, STAMPED AND SIGNED BY THE GENERAL CONTRACTOR BEFORE BEING SUBMITTED TO THE ARCHITECT.

 THE GENERAL CONTRACTOR SHALL DIGITALLY SUBMIT DEFERRED SUBMITTALS TO THE ARCHITECT.
- 3. THE DEFERRED SUBMITTAL ITEMS WILL BE REVIEWED BY THE ENGINEER OR ARCHITECT IN RESPONSIBLE CHARGE. THE ENGINEER OR ARCHITECT WILL ATTACH A LETTER TO THE SUBMITTAL STATING THAT THE DEFERRED ITEM IS IN CONFORMANCE WITH THE DESIGN OF THE STRUCTURE.
- 4. THE APPROVED SUBMITTALS WILL BE RETURNED TO THE GENERAL CONTRACTOR. TWO SETS OF THE DEFERRED SUBMITTAL ARE THEN SUBMITTED TO THE CITY FOR SUBMITTAL CONTRACTOR SHALL MAINTAIN ONE SET OF THE APPROVED SUBMITTAL ON SITE FOR REFERENCE BY THE CITY INSPECTOR.
- 6. THE DEFERRED SUBMITTAL ITEMS SHALL NOT BE INSTALLED UNTIL THE SUBMITTAL DOCUMENTS HAVE BEEN APPROVED BY THE BUILDING OFFICIAL.

 7. SEE STRUCTURAL NOTES FOR ADDITIONAL REQUIREMENTS FOR STRUCTURAL DEFERRED SUBMITTALS.

MATERIALS: CONCRETE FOUNDATIONS, WOOD FRAME W/ BRICK MASONRY & FIBER CEMENT PANELS, TPO & METAL ROOFING.

7. SEE STRUCTURAL NOTES FOR ADDITIONAL DEFERRED SUBMITTAL ITEMS:

EXTERIOR FRAMING, DESIGN, AND INSTALLATION DETAILS PER STRUCTURAL.
 FIRE SPRINKLING DRAWINGS, INCLUDING DESIGN DRAWINGS AND CALCULATIONS.
 FIRE ALARM DRAWINGS AND SPECIFICATIONS.
 JACUZZI DRAWINGS AND SPECIFICATIONS.

CCTV SECURITY CAMERAS AND SECURITY SYSTEM.
 PROJECT TRIPLE PLAY - (PHONE, DATA, T.V.) SHALL BE PROVIDED BY DEFFERED SUBMITTAL.
 CAST IN PLACE STORM WATER DETENTION SYSTEM

SPECIAL INSPECTIONS REQUIREMENTS

SPECIAL INSPECTIONS ARE REQUIRED IN ACCORDANCE WITH IBC 2015 CHAPTER 17, SECTION 1704.

SPECIAL INSPECTORS SHALL KEEP RECORDS OF INSPECTIONS. THE SPECIAL INSPECTOR SHALL FURNISH INSPECTION REPORTS TO THE BUILDING OFFICIAL, AND TO THE REGISTERED DESIGN PROFESSIONALS IN RESPONSIBLE CHARGE. (2015 IBC SECTION 1704.2.4).

SEE PROJECT MANUAL / SPECIFICATIONS, STRUCTURAL, MECHANICAL, PLUMBING, AND ELECTRICAL GENERAL NOTES FOR ADDITIONAL SPECIAL INSPECTION REQUIREMENTS.


	BUILDING AREA - GROSS
NAME	AREA
LEVEL 0	1443 SF
LEVEL 1	1355 SF
	2798 SF

BUILDING AREAS

VICINITY MAP



PROJECT LOCATION -

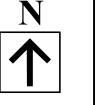

VALVAERE - CABIN

10226 N LIV PL, Park City, Utah


Lot C-07

COVER

	11
Checked By	LL
Drawn By	DPH/EES
Date	10/26/2023
Project Number	20203284





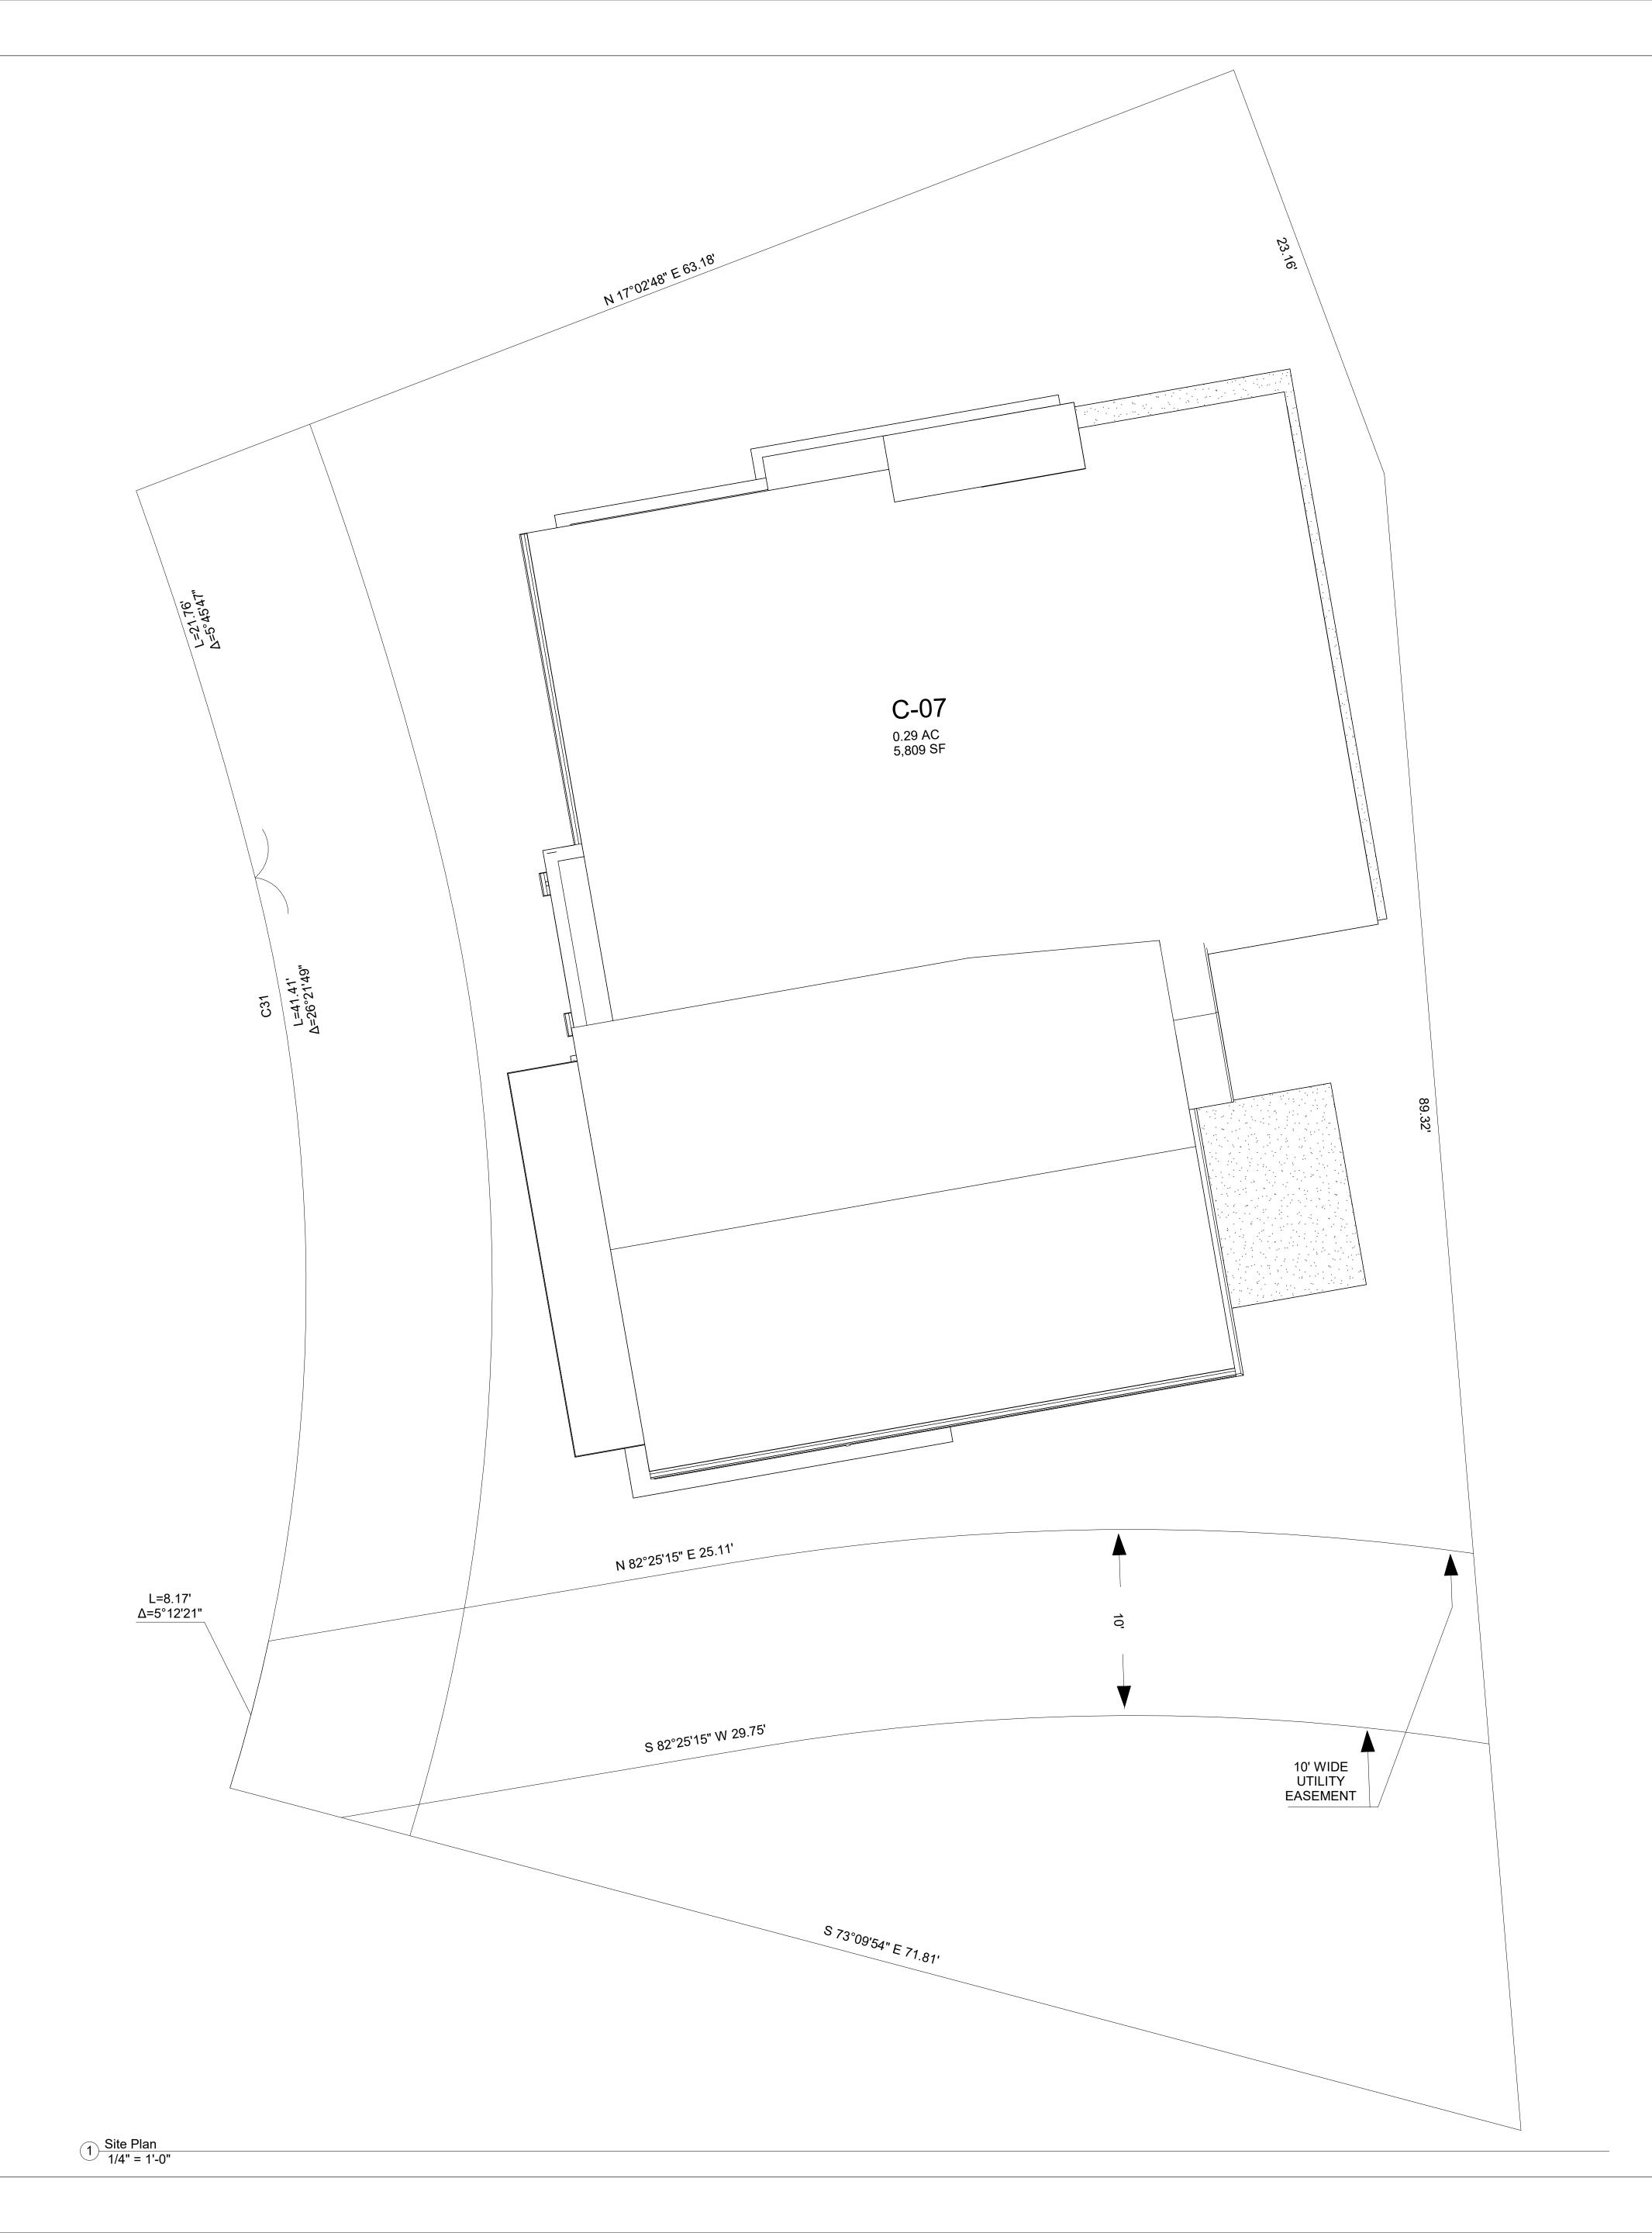





VALVAERE - CABIN B

Emily Schmidt
David Hartung
Glen Erickson
Logan Prochnow
Chloe Lawrence
Mikaela Prochnow

VALVAERE - CABIN B

10226 N LIV PL, Park City, Utah

Lot C-07

SITE

C002		023 10·42·58 PM
hecked By	DPH	.52 P
rawn By	EES	\$
ate 10	0/26/2023	
roject Number	20203284	

1/4" = 1'-0"



VALVAERE - CABIN

Emily Schmidt David Hartung Glen Erickson Logan Prochnow Chloe Lawrence Mikaela Prochnow

VALVAERE - CABIN


10226 N LIV PL, Park City, Utah

Lot C-07


BUILDING AREA ANALYSIS

Project Number	20203284
Date	10/26/2023
Drawn By	DPH
Checked By	EES

G003

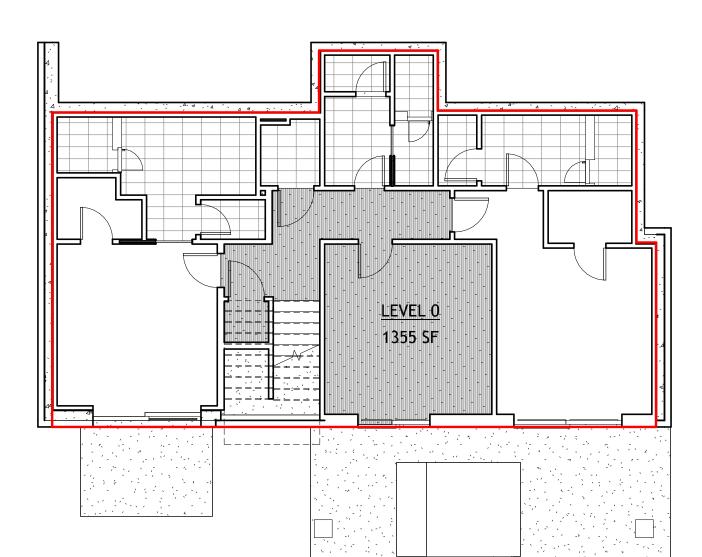


4 AREA PLAN LEVEL 0 - GROSS 1/8" = 1'-0"

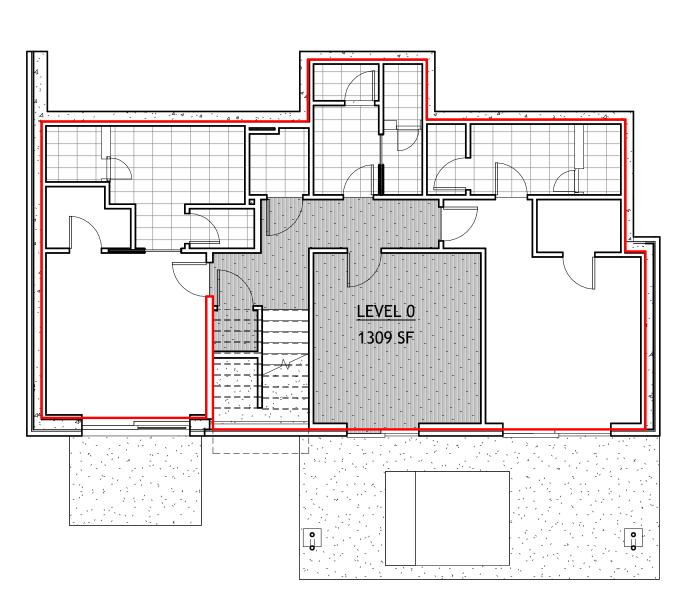


OCCUPANCY: EACH DWELLING LIMITED TO 25 OCCUPANTS

3 AREA PLAN LEVEL 0 - RETAINABLE 1/8" = 1'-0"

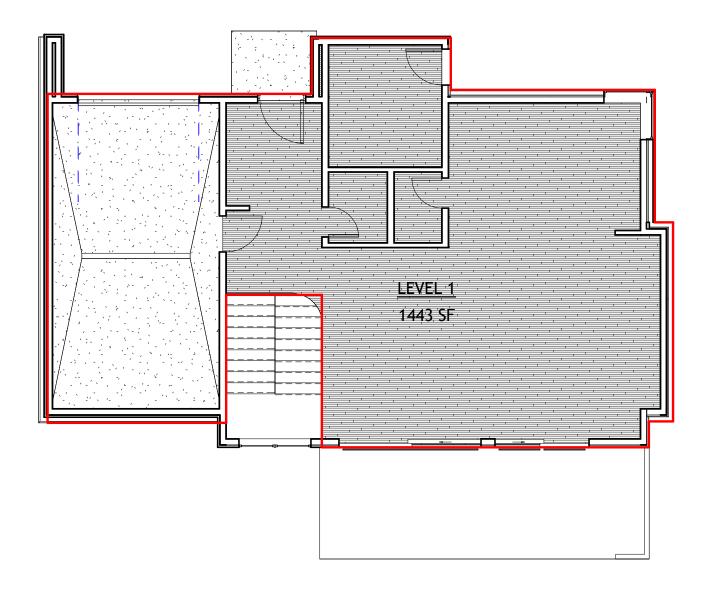

2 AREA PLAN LEVEL 1 - GROSS 1/8" = 1'-0"

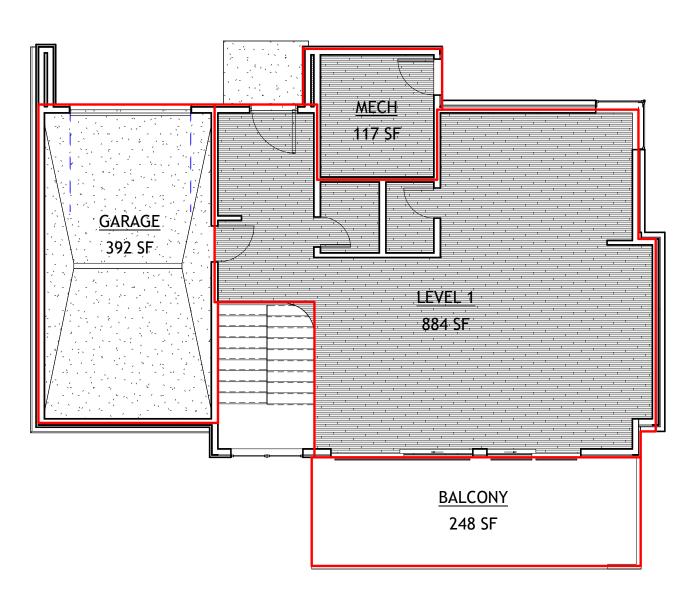

1 AREA PLAN LEVEL 1 - RETAINABLE 1/8" = 1'-0"


BUILDING AREA - GROSS				
NAME	AREA			
LEVEL 0	1443 SF			
LEVEL 1	1355 SF			
	2798 SF			

BUILDING AREA - UNFINISHED				
NAME	AREA			
LEVEL 0	1309 SF			
LEVEL 1	884 SF			
	2193 SF			
	BUILDING AREA - UNFINISHED			
NAME	AREA			
GARAGE	392 SF			
MECH	117 SF			
	508 SF			
	BUILDING AREA - TOTAL			
	AREA			
	2701 SF			
	BUILDING AREA - BALCONY			
NAME	AREA			
BALCONY	248 SF			

GENERAL NOTES:

- THE DETAILS HERE ARE A SUMMARY DESCRIPTION OF THE ASSEMBLIES SHOWN. FIRE AND SOUND RATED ASSEMBLIES ARE REQUIRED TO MEET THE FULL TESTING SPECIFICATIONS AS GIVEN BY THE TESTING AGENCY AS INDICATED BY THE TEST NUMBER PROVIDED.
- THE SPECIFICATIONS INCLUDE A COPY OF ALL NOTED ASSEMBLIES. THE CONTRACTOR IS REQUIRED TO INSTALL ALL PRODUCTS IN COMPLIANCE WITH THE ASSEMBLY REQUIREMIENTS AND SHALL HAVE A COPY OF THE FULL ASSEMBLY ON SITE.
- 2x4 WOOD STUD R-VALUE = 4.38
- 4. 2x6 WOOD STUD R-VALUE = 6.88
- BATT INSULATION R-VALUE = 19 RIDGE INSULATION R-VALUE = 2.16
- STONE VENEER R-VALUE = 0.2 8. GYPSUM WALL BAORD R-VALUE = 0.5625
- CONCRETE R-VALUE = 0.8 1.0 10. PLYWOOD R-VALUE = 0.62
- 11. WOOD SIDING R-VALUE = 0.8
- 12. METAL PANEL R-VALUE = 0.61



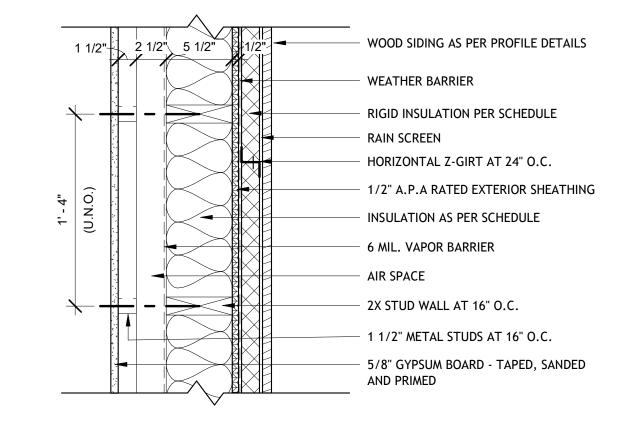

FRAMING - WOOD SIDING WALL

9 ASSEMBLY B


1 1/2" = 1'-0"



800 N 6th St Wahpeton, North Dakota


VALVAERE - CABIN

Emily Schmidt David Hartung Glen Erickson Logan Prochnow Chloe Lawrence Mikaela Prochnow

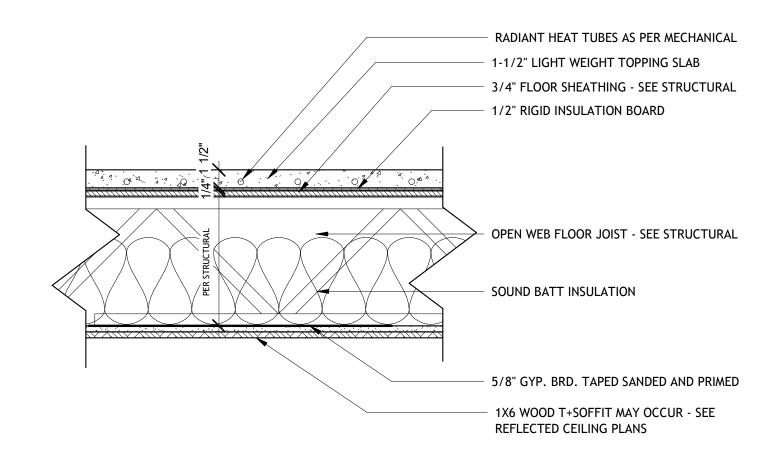

8 FLOOR - ASSEMBLY DETAIL 1/2" = 1'-0"


4 ASSEMBLY 1 1/2" = 1'-0"

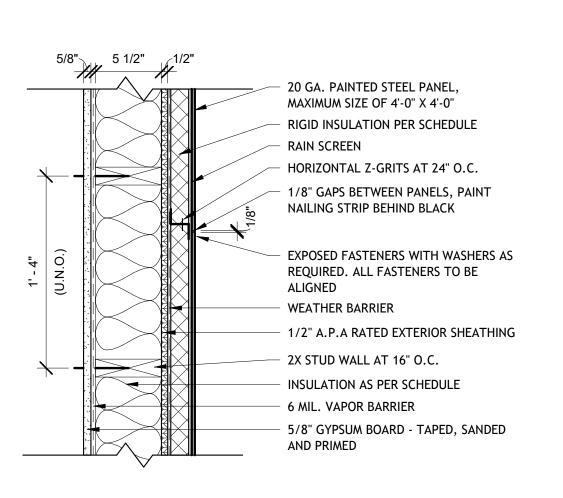


FRAMING - METAL PANEL WALL

ASSEMBLY

1 1/2" = 1'-0"

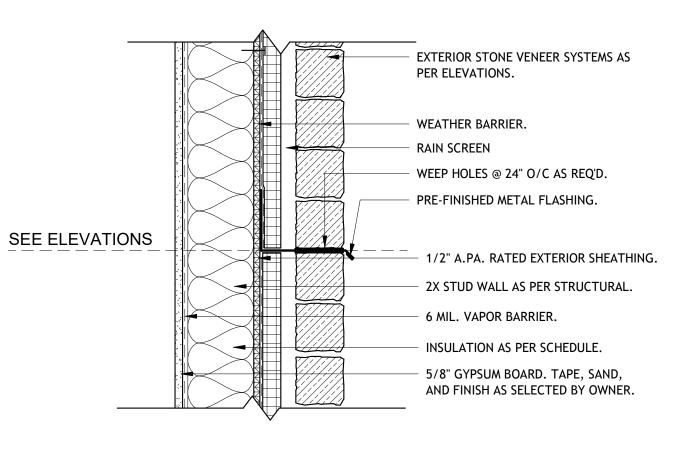

6 FRAMING - FLASHING DETAIL @STONE 1 1/2" = 1'-0"

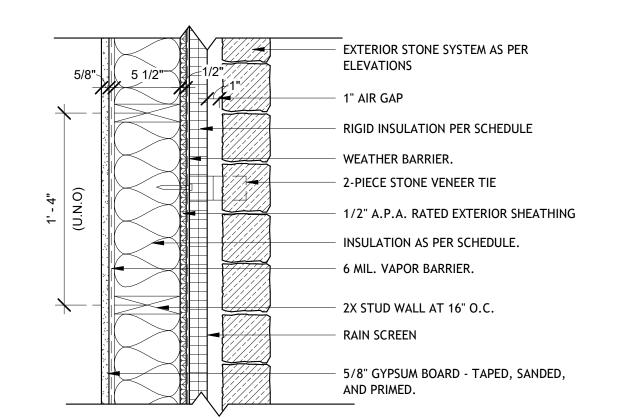

2X4 OR 2X6 WALL PER PLAN - ALL

INSULATION AS PER SCHEDULE

5/8" GYPSUM BOARD - TAPED,

PLUMBING WALLS 2X6

SANDED AND PRIMED


2X STUD WALL AT 16" O.C.

FRAMING - STONE MASONRY WALL

S 1 1/2" = 1'-0"

FRAMING - TYPICAL INTERIOR WALL

1 ASSEMBLY 1 1/2" = 1'-0"

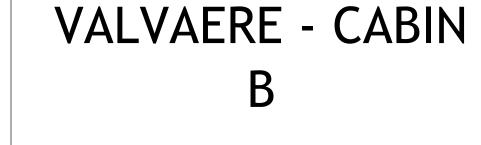

10226 N LIV PL, Park City, Utah

Lot C-07

WALL ASSEMBBLIES


Project Number	20203284
Date	10/26/2023
Drawn By	MFL
Checked By	EES/DPH

G004

As indicated

Scale:

WEATHER BARRIER RIGID INSULATION PER SCHEDULE FOUNDATION WALL AS PER STRUCTURAL. 2-PIECE STONE VENEER TIE INSULATION AS PER SCHEDULE. 6 MIL. VAPOR BARRIER. 5/8" GYPSUM BOARD. TAPE, SAND, AND FINISH AS SELECTED BY OWNER. 2X STUD WALL AS PER STRUCTURAL. - RAIN SCREEN FRAMING - STONE OVER CONCRETE

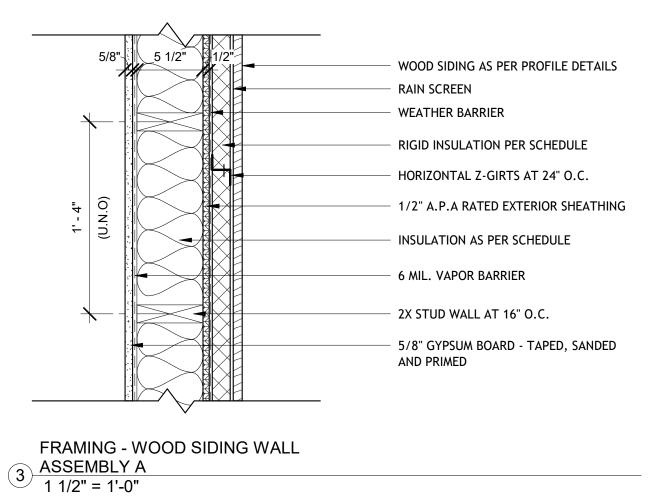


MODIFIED ASPHALT SPRAY MEMBRANE (O.A.E) APPLIED TO FND. BELOW FINISH GRADE. CONCRETE FOUNDATION AS PER STRUCT. INSULATION AS PER SCHEDULE. 1/2" A.P.A RATED EXTERIOR SHEATHING. WALL FINISH PER INTERIOR DESIGN 2X STUD WALL AT 16" O.C. FRAMING - CONCRETE FURR OUT 2 ASSEMBLY 1 1/2" = 1'-0"


3/4" DRAINAGE BOARD APPLIED TO MEMBRANE (O.A.E) APPLIED TO

"TUF-N-DRY OR EQUAL POLYMER

FND. BELOW FINISH GRADE

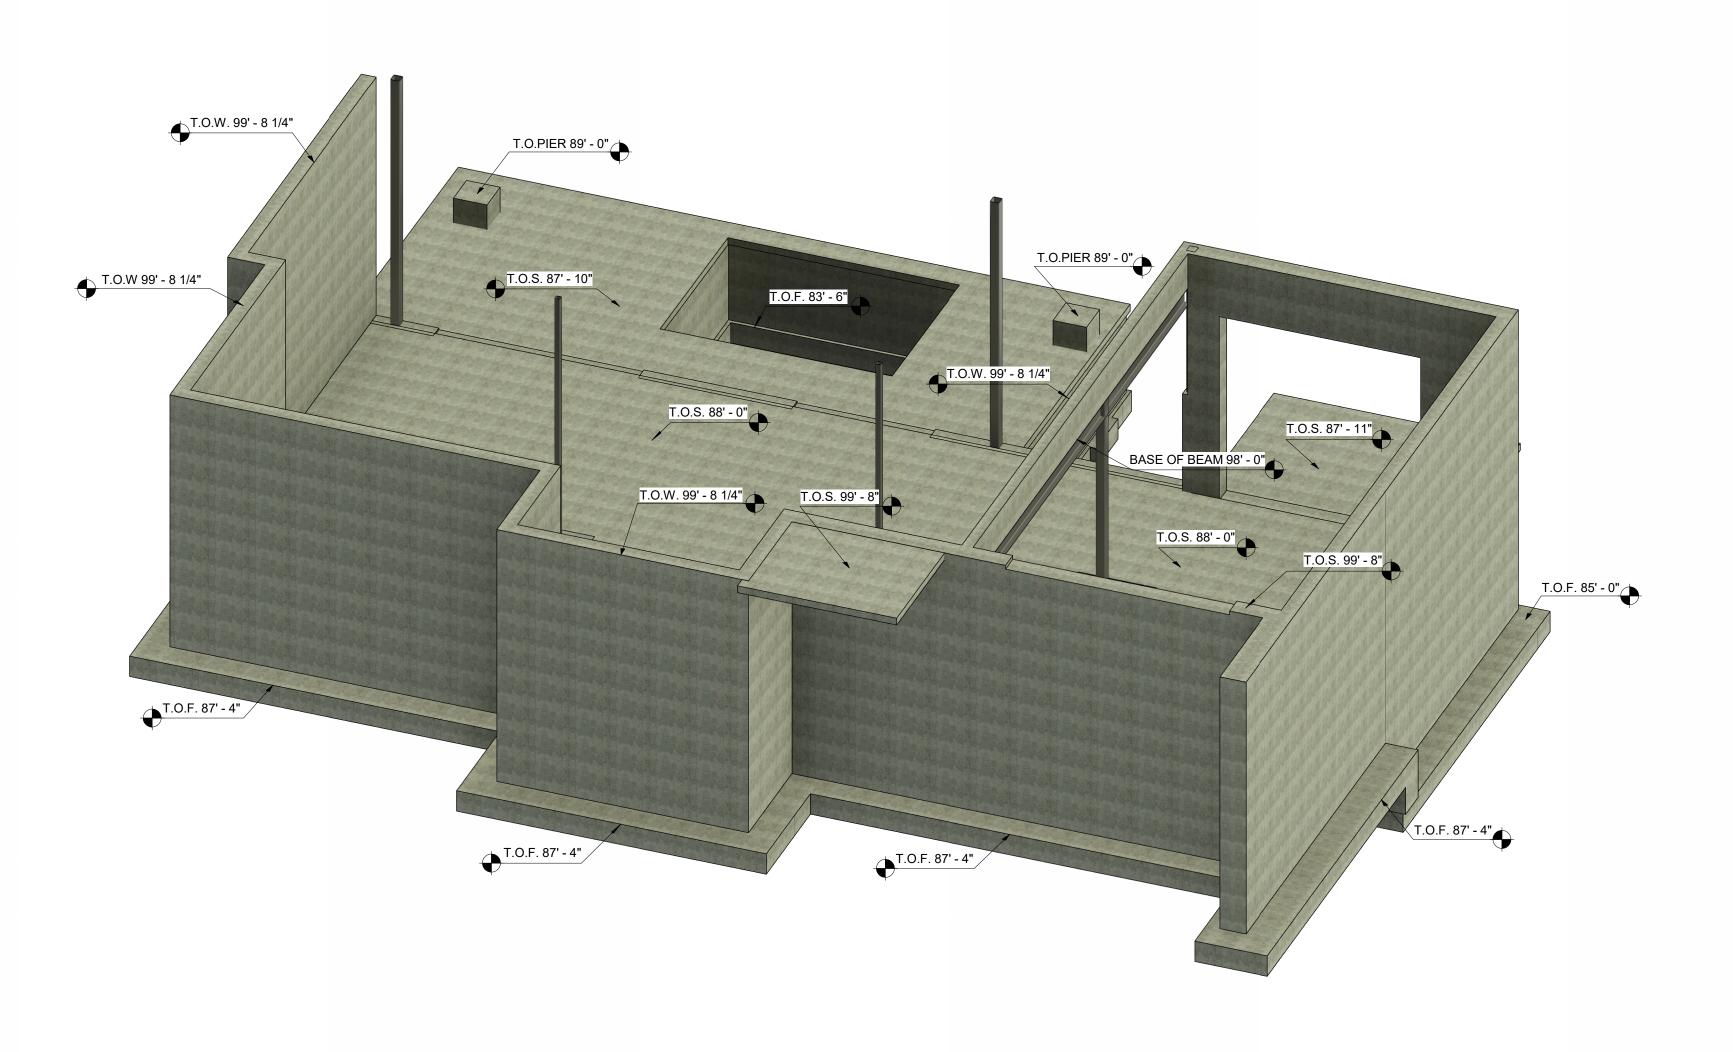

2 FULL FOUNDATION WALLS FRONT

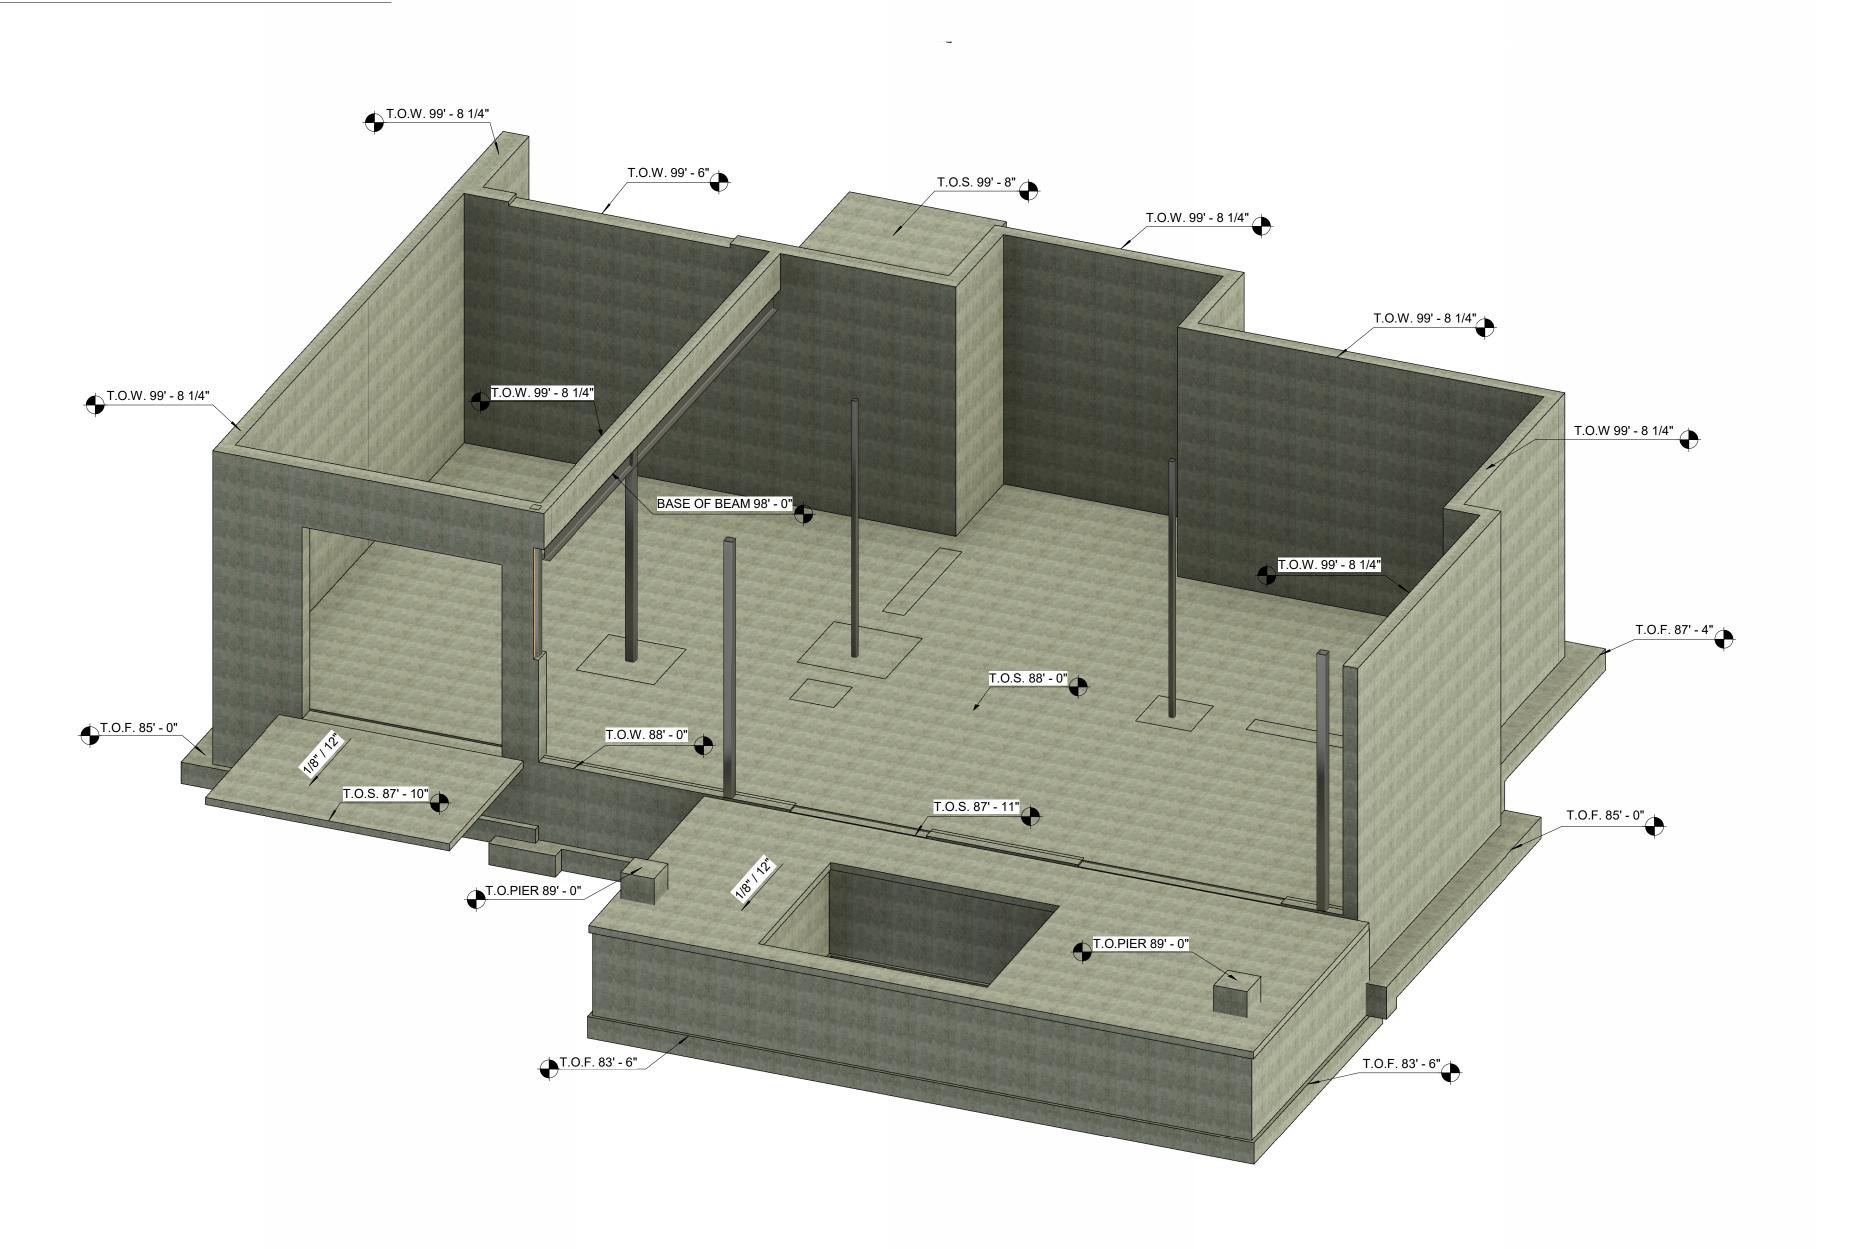





800 N 6th St Wahpeton, North Dakota

VALVAERE - CABIN B

Emily Schmidt
David Hartung
Glen Erickson
Logan Prochnow
Chloe Lawrence
Mikaela Prochnow

VALVAERE - CABIN B

10226 N LIV PL, Park City, Utah

Lot C-07

ARCH. FOUNDATION PRESPECTIVES

Project Number	20203284
Date	10/26/2023
Drawn By	DPH
Checked By	FFS

A 102A


FLOOR PLAN GENERAL NOTES:


- 1. ALL DIMENSIONS ARE TO INTERIOR FACE-OF-STUD (F.O.S.) UNLESS NOTED OTHERWISE.
- 2. CEILING HEIGHTS MEASURED FROM PLYWOOD OR CONCRETE SEE SECTIONS
- 3. REFER TO ENLARGED PLANS FOR ALL UNIT DIMENSIONS, WINDOW TYPES, DOORS AND WALLS.
- 4. REFER TO ENLARGED PLANS FOR ALL DECKS/PATIOS.
- 5. COORDINATE WITH ALL ENLARGED PLANS FOR ADDITIONAL INFORMATION AND DETAILS.
- 6. ALL TOPPING SLABS MUST BE POURED AFTER ROOF IS COMPLETE AND BUILDING IS DRIED IN.
 7. SEE SHEET A002 FOR PROJECT GENERAL NOTES AND SHEET A003 FOR PROJECT KEYNOTES.
 REVIEW ALL NOTES PRIOR TO CONSTRUCTION.
- 8. COORDINATE WITH STRUCTURAL FRAMING PLANS AND SHEAR WALL PLANS FOR LOCATIONS OF COLUMNS, BEAMS, SHEAR WALLS, ETC.
- 9. COORDINATE WITH BUILDER/OWNER FOR ALL INTERIOR FINISHES
- 10. COORDINATE WITH ELECTRICAL DRAWINGS FOR ALL LIGHTING, POWER AND DATA REQUIREMENTS.
- 11. ALL EXTERIOR WALLS ARE ASSUMED TO BE 2X6 STUD WALLS UNLESS SHOWN/NOTED OTHERWISE.

12. ALL INTERIOR WALLS ARE ASSUMED TO BE 2X4 STUD WALLS UNLESS SHOWN/NOTED OTHERWISE.

- 13. ALL ROOF TRUSSES TO HAVE RAISED ENERGY HEEL CONSTRUCTION TO ALLOW FOR FULL DEPTH INSULATION OVER EXTERIOR WALLS (COORDINATE INSULATION REQUIREMENTS WITH
- 14. FOR TYPICAL WALL ASSEMBLIES/DETAILS SEE SHEET G004.

RESCHECKS).

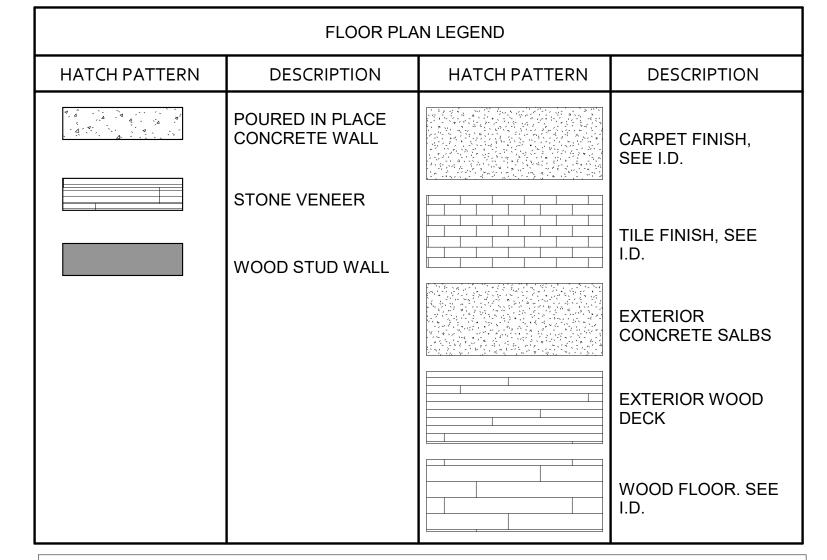

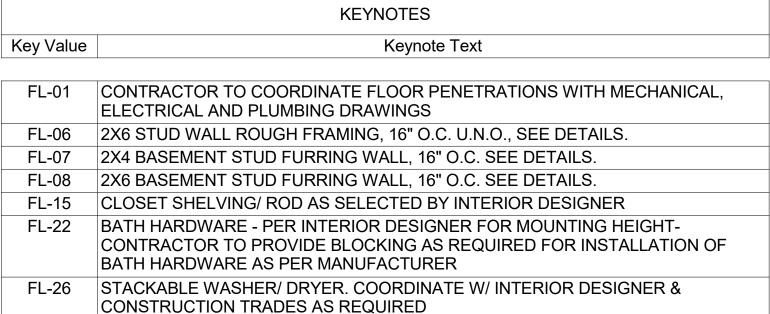

FL-46 HOT TUB BULLFROG A8 SERIES. CONFIRM PIT SIZE AND DEPTH REQUIREMENTS

WITH MANUFACTURER
FL-49 W.C. PER INTERIOR DESIGNER


FL-52 PIPE STEEL COLUMNS - SEE STRUCTURAL FOR SIZE AND SPECS.

FL-53 BATHROOM SINK - VANITY PER INTERIOR DESIGNER

FL-54 ALL CASEWORK - PER INTERIOR DESIGN

FL-59 CAST IN PLACE CONCRETE COLUMN PER STRUCTURAL

FL-64 BATHTUB AS PER INTERIOR DESIGNER

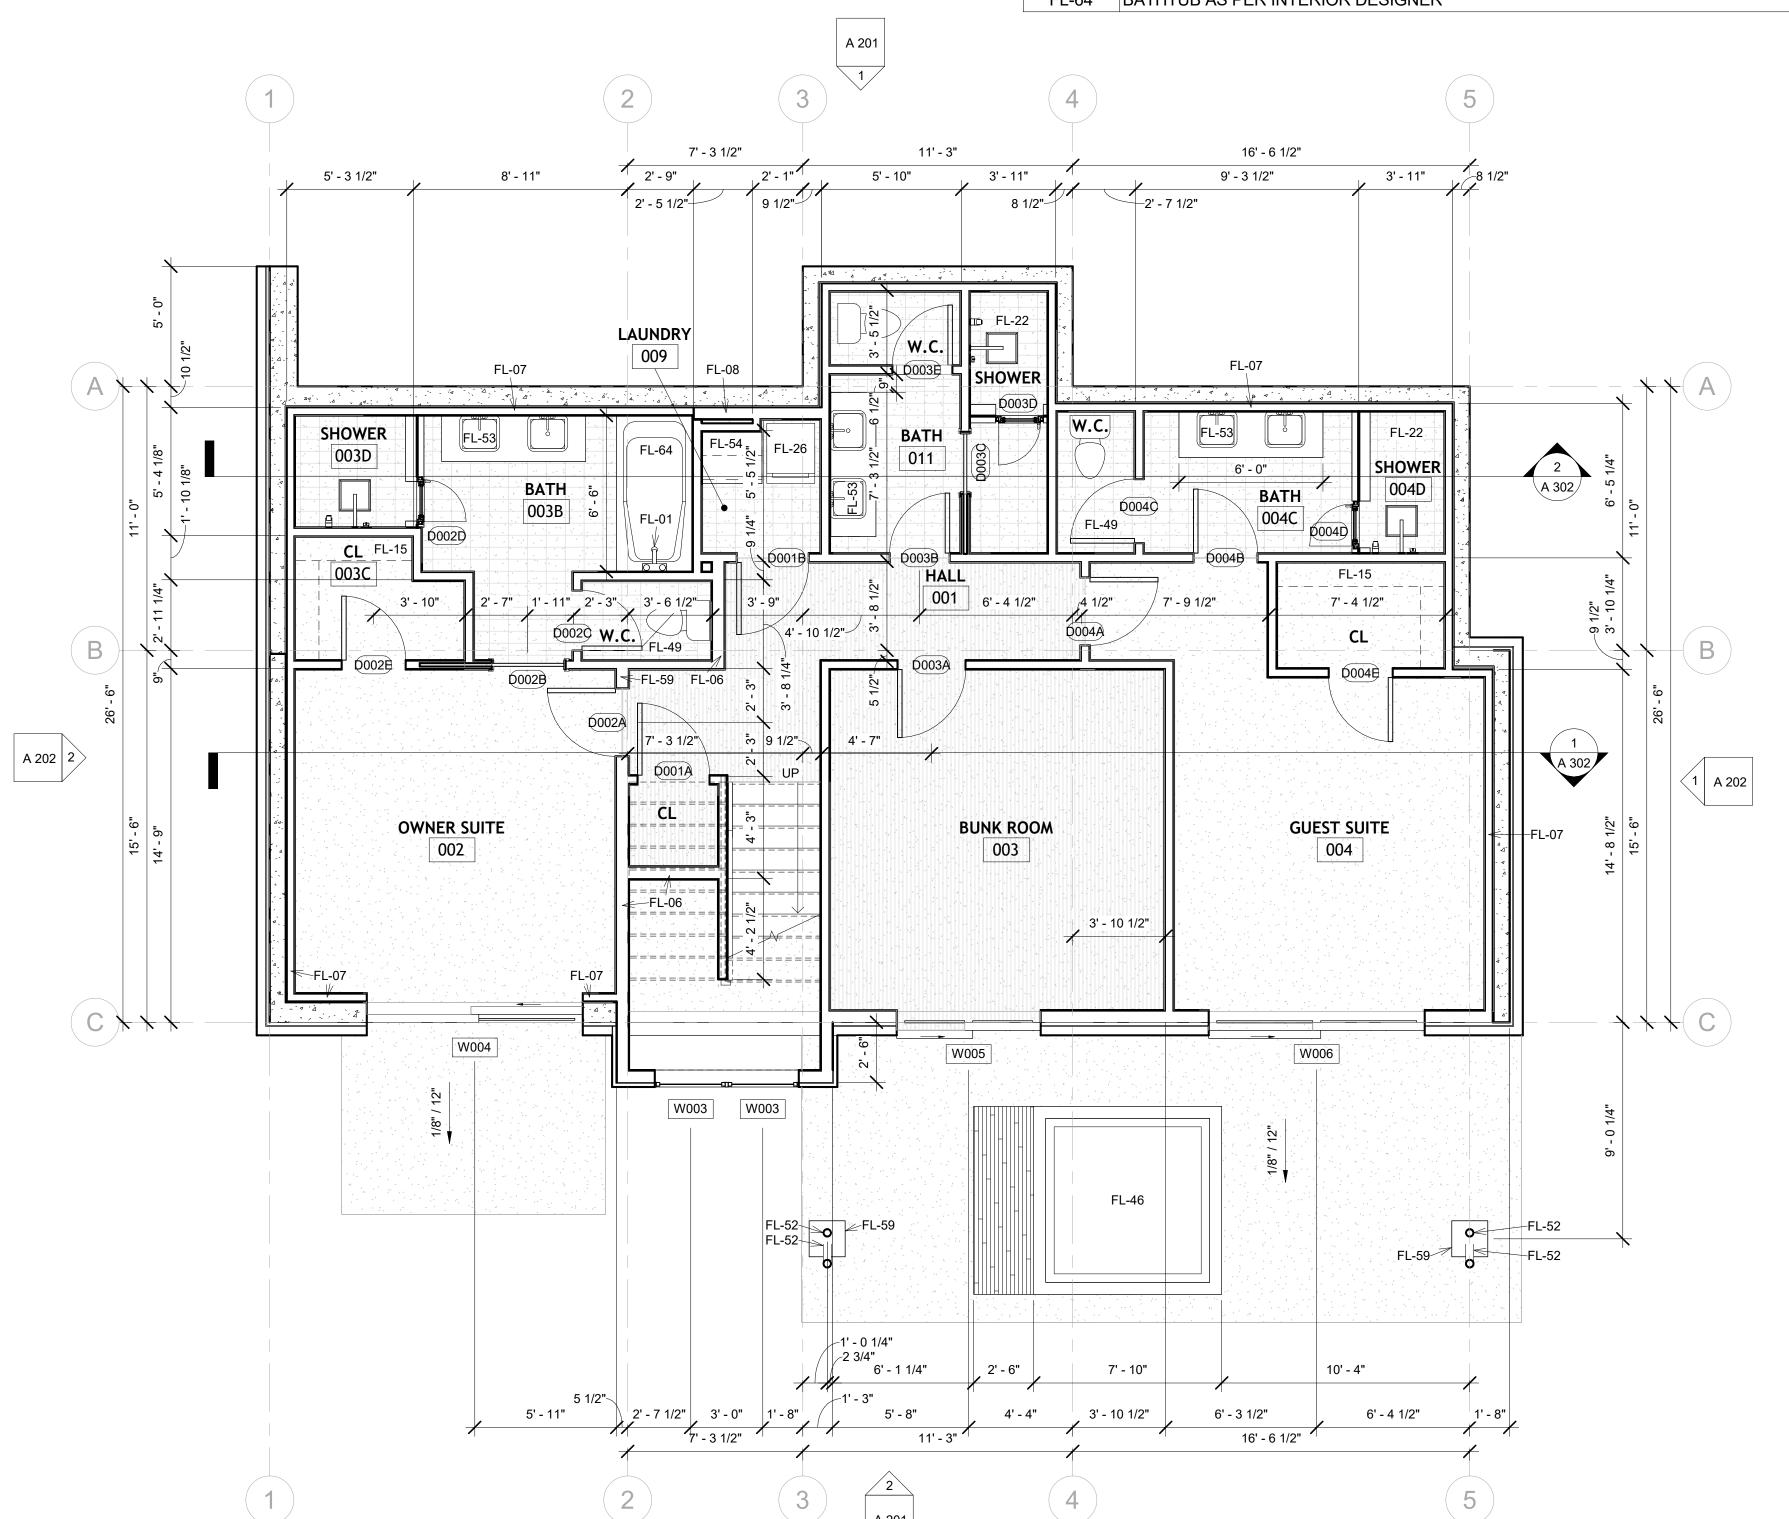





800 N 6th St Wahpeton, North Dakota

VALVAERE - CABIN B

Emily Schmidt
David Hartung
Glen Erickson
Logan Prochnow
Chloe Lawrence
Mikaela Prochnow

VALVAERE - CABIN B

10226 N LIV PL, Park City, Utah

Lot C-07

LEVEL 0 FLOOR PLAN

 Project Number
 20203284


 Date
 10/26/2023

 Drawn By
 DPH

 Checked By
 EES

A 103

ale:

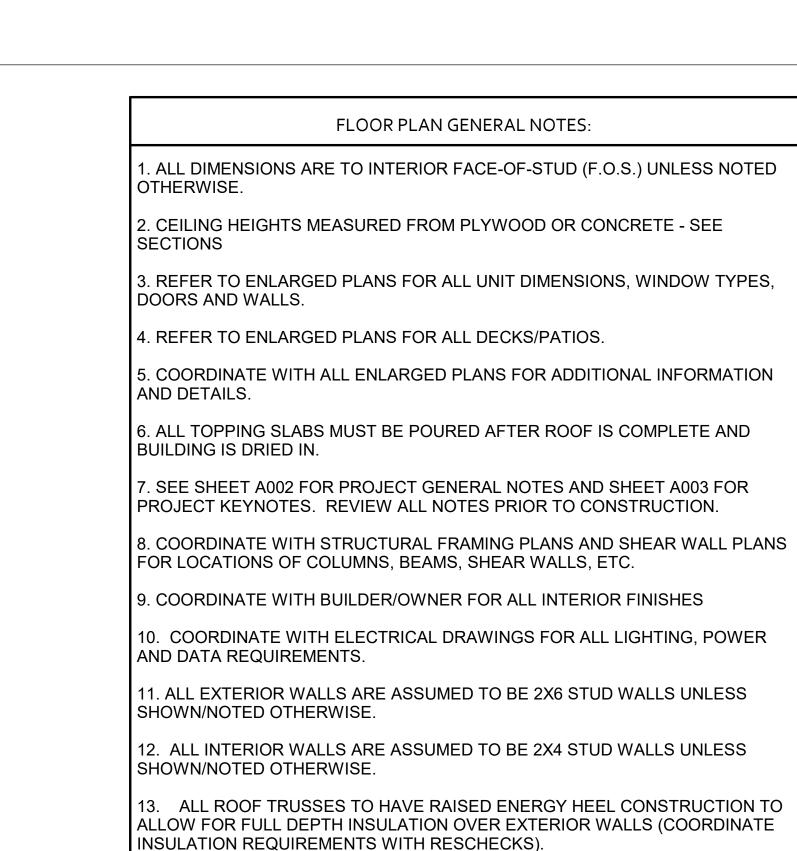

14. FOR TYPICAL WALL ASSEMBLIES/DETAILS SEE SHEET G004.

		FLOOR PLAN LEGEND							
HAT		HATCH PATTERN	DESCRIPTION	HATCH PATTERN	DESCRIPTION				
			POURED IN PLACE CONCRETE WALL STONE VENEER		CARPET FINISH, SEE I.D.				
			WOOD STUD WALL		TILE FINISH, SEE I.D.				
					EXTERIOR CONCRETE SALBS				
					EXTERIOR WOOD DECK				



KEYNOTES Key Value Keynote Text FL-06 2X6 STUD WALL ROUGH FRAMING, 16" O.C. U.N.O., SEE DETAILS. FL-19 WOOD LOCKERS AS SELECTED BY OWNER/ INT. DESIGNER FL-20 WOOD BENCH PER INTERIORS FL-27 DISHWASHER, COORD, W/ INT. DESIGNER & CONSTRUCTION TRADES AS FL-28 REFRIGERATOR/ FREEZER COMBO. COORDINATE W/ INT. DESIGNER & CONSTRUCTION TRADES AS REQUIRED FL-32 GAS RANGE AS SELECTED BY INTERIOR DESIGNER. COORD. W/ INT. DESIGNER AND CONSTRUCTION TRADES AS REQUIRED FL-37 CONNECT DOWNSPOUT TO STORM DRAIN CONNECTION AT GRADE FL-49 W.C. PER INTERIOR DESIGNER FL-54 ALL CASEWORK - PER INTERIOR DESIGN FL-56 KITCHEN SINK, HARDWARE AND CABINETRY PER INTERIOR DESIGNER -COORDINATE W/PLUMBING, ELECTRICAL AND MECHANICAL FL-68 BBQ-GRILL AS SELECTED BY OWNER-COORDINATE WITH MECHANICAL FOR NATURAL GAS

WOOD FLOOR. SEE



800 N 6th St Wahpeton, North Dakota

VALVAERE - CABIN B

Emily Schmidt
David Hartung
Glen Erickson
Logan Prochnow
Chloe Lawrence
Mikaela Prochnow

VALVAERE - CABIN B

> 10226 N LIV PL, Park City, Utah

> > Lot C-07


LEVEL 1 FLOOR PLAN

Project Number	20203284
Date	10/26/2023
Drawn By	DPH
Checked By	EES

A 104

As in

		2	3 50' - 0"	5	
	1' - 3" 6' - 5" 6' - 9	7' - 3 1/2" 7' - 9" 9 1/2"	11' - 3" 4' - 10" 5' - 7 1/2"	16' - 6 1/2" 14' - 11 7/8" 1' - 6 5/8" 1' - 8"	/
			FL-37 W106 FL-37		
11 0 S: - 0	(D)	T.O.S 99' - 8" FL-19 T.O.F. 100' - 0 1/ FL-20 T.O.F. 100' - 1/ ENTRY 100 FL-19	2"	FL-28 FL-28 KITCHEN 5' - 5 3/4"	2 A 302 I.1-6 3/4"
B	GARAGE 101	0101B 3/8" / 12" N 9 1/2"	PANTRY FL-54	FL-27 FL-56	B92
A 202 2	1/8"/12"	DN		GREAT ROOM	A 302 1 A 202
2 6	W100 W100	W101 W101	W104	W112	56"
				T.O.F. 100' - 0"	
	4' - 6"	3' - 8 1/2" 3' - 1" 3' - 0" 1' - 8"	8' - 1" 3' - 2" 11' - 3"	7' - 10" 8' - 8 1/2" 1' - 8"	
	1	2	3 A 201	5	

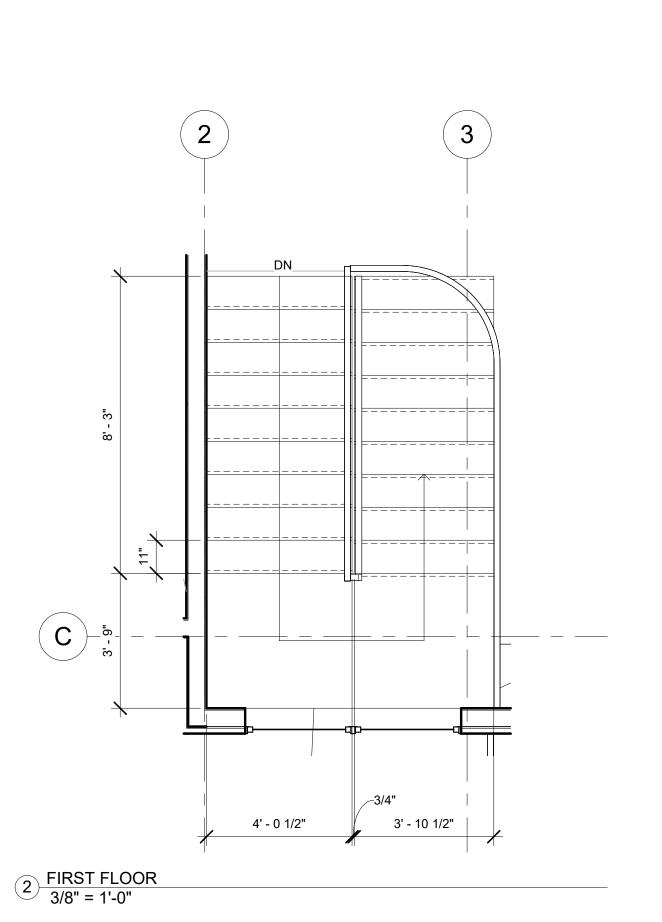

1) FIRST FLOOR 1/4" = 1'-0"

ale:

ROOF PLAN GENERAL NOTES:

1. SEE SHEET G002 FOR PROJECT GENERAL NOTES. REVIEW ALL NOTES PRIOR TO CONSTRUCTION.

2. FLASH ALL ROOF PENETRATIONS WHETHER SHOWN OR NOT.

3. COORDINATE WITH MECHANICAL, PLUMBING, AND ELECTRICAL DRAWINGS FOR ALL ROOF PENETRATIONS.

4. PROVIDE HEAT TRACE IN ALL RAIN GUTTERS, DOWN SPOUTS AND RAIN CHAINS.

5. ROOFING CONTRACTOR SHALL REVIEW ALL SUBSTRATES PRIOR TO BEGINNING WORK.

6. ALL ROOFING SHALL BE REVIEWED PRIOR TO INSTALLATION.

7. CONTRACTOR IS RESPONSIBLE TO ASSUME THAT NO ROOF SLOPES CREATE DEAD SPOTS OR LOW SPOTS THAT WILL PREVENT DRAINAGE.

8. ALL ROOF TRUSSES TO HAVE RAISED ENERGY HEEL CONSTRUCTION TO ALLOW FOR FULL DEPTH INSULATION OVER EXTERIOR WALLS (COORDINATE INSULATION REQUIREMENTS WITH RESCHECKS).

9. DIMENSIONS SHOWN ON THE ROOF PLAN ARE FROM THE EXTERIOR SIDE OF THE STUD FRAMING BELOW.

2 A 504

9" / 12"

8' - 10 1/2"

7' - 3 1/2"

9" / 12"

		ROOF P	LAN LEGEND	
	HATCH PATTERN	DESCRIPTION	HATCH PATTERN	DESCRIPTION
		MEMBRANE ROOFING SYSTEM		
		STANDING SEAM METAL ROOFING SYSTEM		
		LOCATION OF SNOW RETENTION SYSTEM - TO BE DESIGNED AND ENGINEERED BY OTHERS		
	D.S.	RAIN GUTTER WITH DOWN SPOUT		

ROOF PLAN KEYNOTES

LINE OF WALL BELOW ROOF- SEE OVERALL AND ENLARGED PLANS

OF CRICKETS SHALL MATCH THAT OF PRIMARY ROOF (MIN.).

STEEL PLATE AWNING - SEE DETAILS

CHIMNEY SLOPED STONE CAP

SLOPE GUTTER TOWARDS SCUPPER THROUGH WALL -FLOW TO OVERBUILD ROOF

PROJECTION OF WALLS BELOW,

PROJECTION OF WALLS BELOW

16' - 6 1/2"

Keynote Text

CRICKET, AS INDICATED BY HATCHED AREA - MAINTAIN DRAINAGE AWAY FROM ALL

CHIMNEY AND MECH. EQUIPMENT PENETRATIONS. SLOPE AND ROOFING MATERIAL

2 A 302

Key Value

RF-22

OVERBUILD
MEMBRANE TPO
ROOFING - SLOPE
TOWARDS SCUPPERCOLLECTOR BOXES







800 N 6th St Wahpeton, North Dakota

VALVAERE - CABIN

Emily Schmidt David Hartung Glen Erickson Logan Prochnow Chloe Lawrence Mikaela Prochnow

VALVAERE - CABIN

10226 N LIV PL, Park City, Utah

ROOF PLAN

Project Number	20203284
Date	10/26/2023
Drawn By	EES
Checked By	DPH

Lot C-07

1 LEVEL 1 ROOF BEARING 2 1/4" = 1'-0"

A 202 2

RELECTED CEILING PLAN GENERAL NOTES

- 1. ALL DIMENSIONS ARE TO INTERIOR FACE-OF-STUD (F.O.S.) UNLESS NOTED OTHERWISE.
- 2. ALL CEILING HEIGHTS MEASURED FORM TOP OF PLYWOOD OR CONCRETE SLAB TO BOTTOM OF CEILING FRAMING, U.N.O. -SEE SECTIONS
- 3. REFER TO ENLARGED PLANS FOR ALL UNITS DIMENSIONS, WINDOW TYPES, DOORS AND WALLS.
- 4. REFER TO ENLARGED PLANS FOR ALL DECKS.
- 5. COORDINATE WITH ALL ENLARGED PLANS FOR ADDITIONAL INFORMATION AND DETAILS.
- 6. SEE SHEET G002 FOR PROJECT SPECIFICATION LIST. REVIEW ALL NOTES PRIOR TO CONSTRUCTION.
- 7. COORDINATE WITH ELECTRICAL DRAWINGS FOR ALL LIGHTING, POWER AND DATA REQUIREMENTS.
- 8. ALL INTERIOR FINISHES ARE NOTED FOR CONCEPT ONLY. SEE INTERIOR DRAWINGS FOR MATERIAL SPECIFICATIONS. COLORS, PATTERNS, AND OTHER REQUIREMENTS PRIOR TO INSTALLATION.

CEILING TAG SYMBOL	DESCRIPTION
C1 (−CEILING TYPE −HEIGHT
	HEIGHT

	R	EFLECTED CEILING PLA	N MATERIAL LEGEND		
HATCH PATTERN	TYPE	DESCRIPTION	HATCH PATTERN	TYPE	DESCRIPTION
	CT-1	5/8" GYPSUM BOARD AT FRAMING.		CT-4	WOOD CEILING AT FRAMING AS PER OWNER
	CT-1A	5/8" GYPSUM BOARD AT 2X4 DROP CEILING.			
				CT-5	EXPOSED UNDERSIDE OF DECKING
	CT-2A	5/8" WATER RESISTANT GYPSUM BOARD AT 2X4 DROP CEILING.			EXPOSED STEEL PLATE

	REFLECTED CEILING PLAN MATERIAL PLAN
Key Value	Keynote Text
CG-03	STRUCTURAL BEAM- SEE STRUCTURAL DRAWINGS/BEAM TO BE PRIMED AND PAINTED AT ALL EXTERIOR LOCATIONS, PAINT COLOR AT ALL INTERIOR LOCATIONS PER INTERIOR DESIGN.
CG-10	STEEL PLATE AWNING.
CG-11	HEAVY TIMBER - SEE STRUCTURAL

CG-12 CEILING SOFFIT 4"WX6"H TO COVER STEEL BEAM





800 N 6th St Wahpeton, North Dakota

VALVAERE - CABIN

Emily Schmidt David Hartung Glen Erickson Logan Prochnow Chloe Lawrence Mikaela Prochnow

VALVAERE - CABIN


10226 N LIV PL, Park City, Utah

Lot C-07

LEVEL 0 CEILING PLAN

Project Number	20203284	
Date	10/26/2023	
Drawn By	DPH	
Checked By	EES	1

A 106

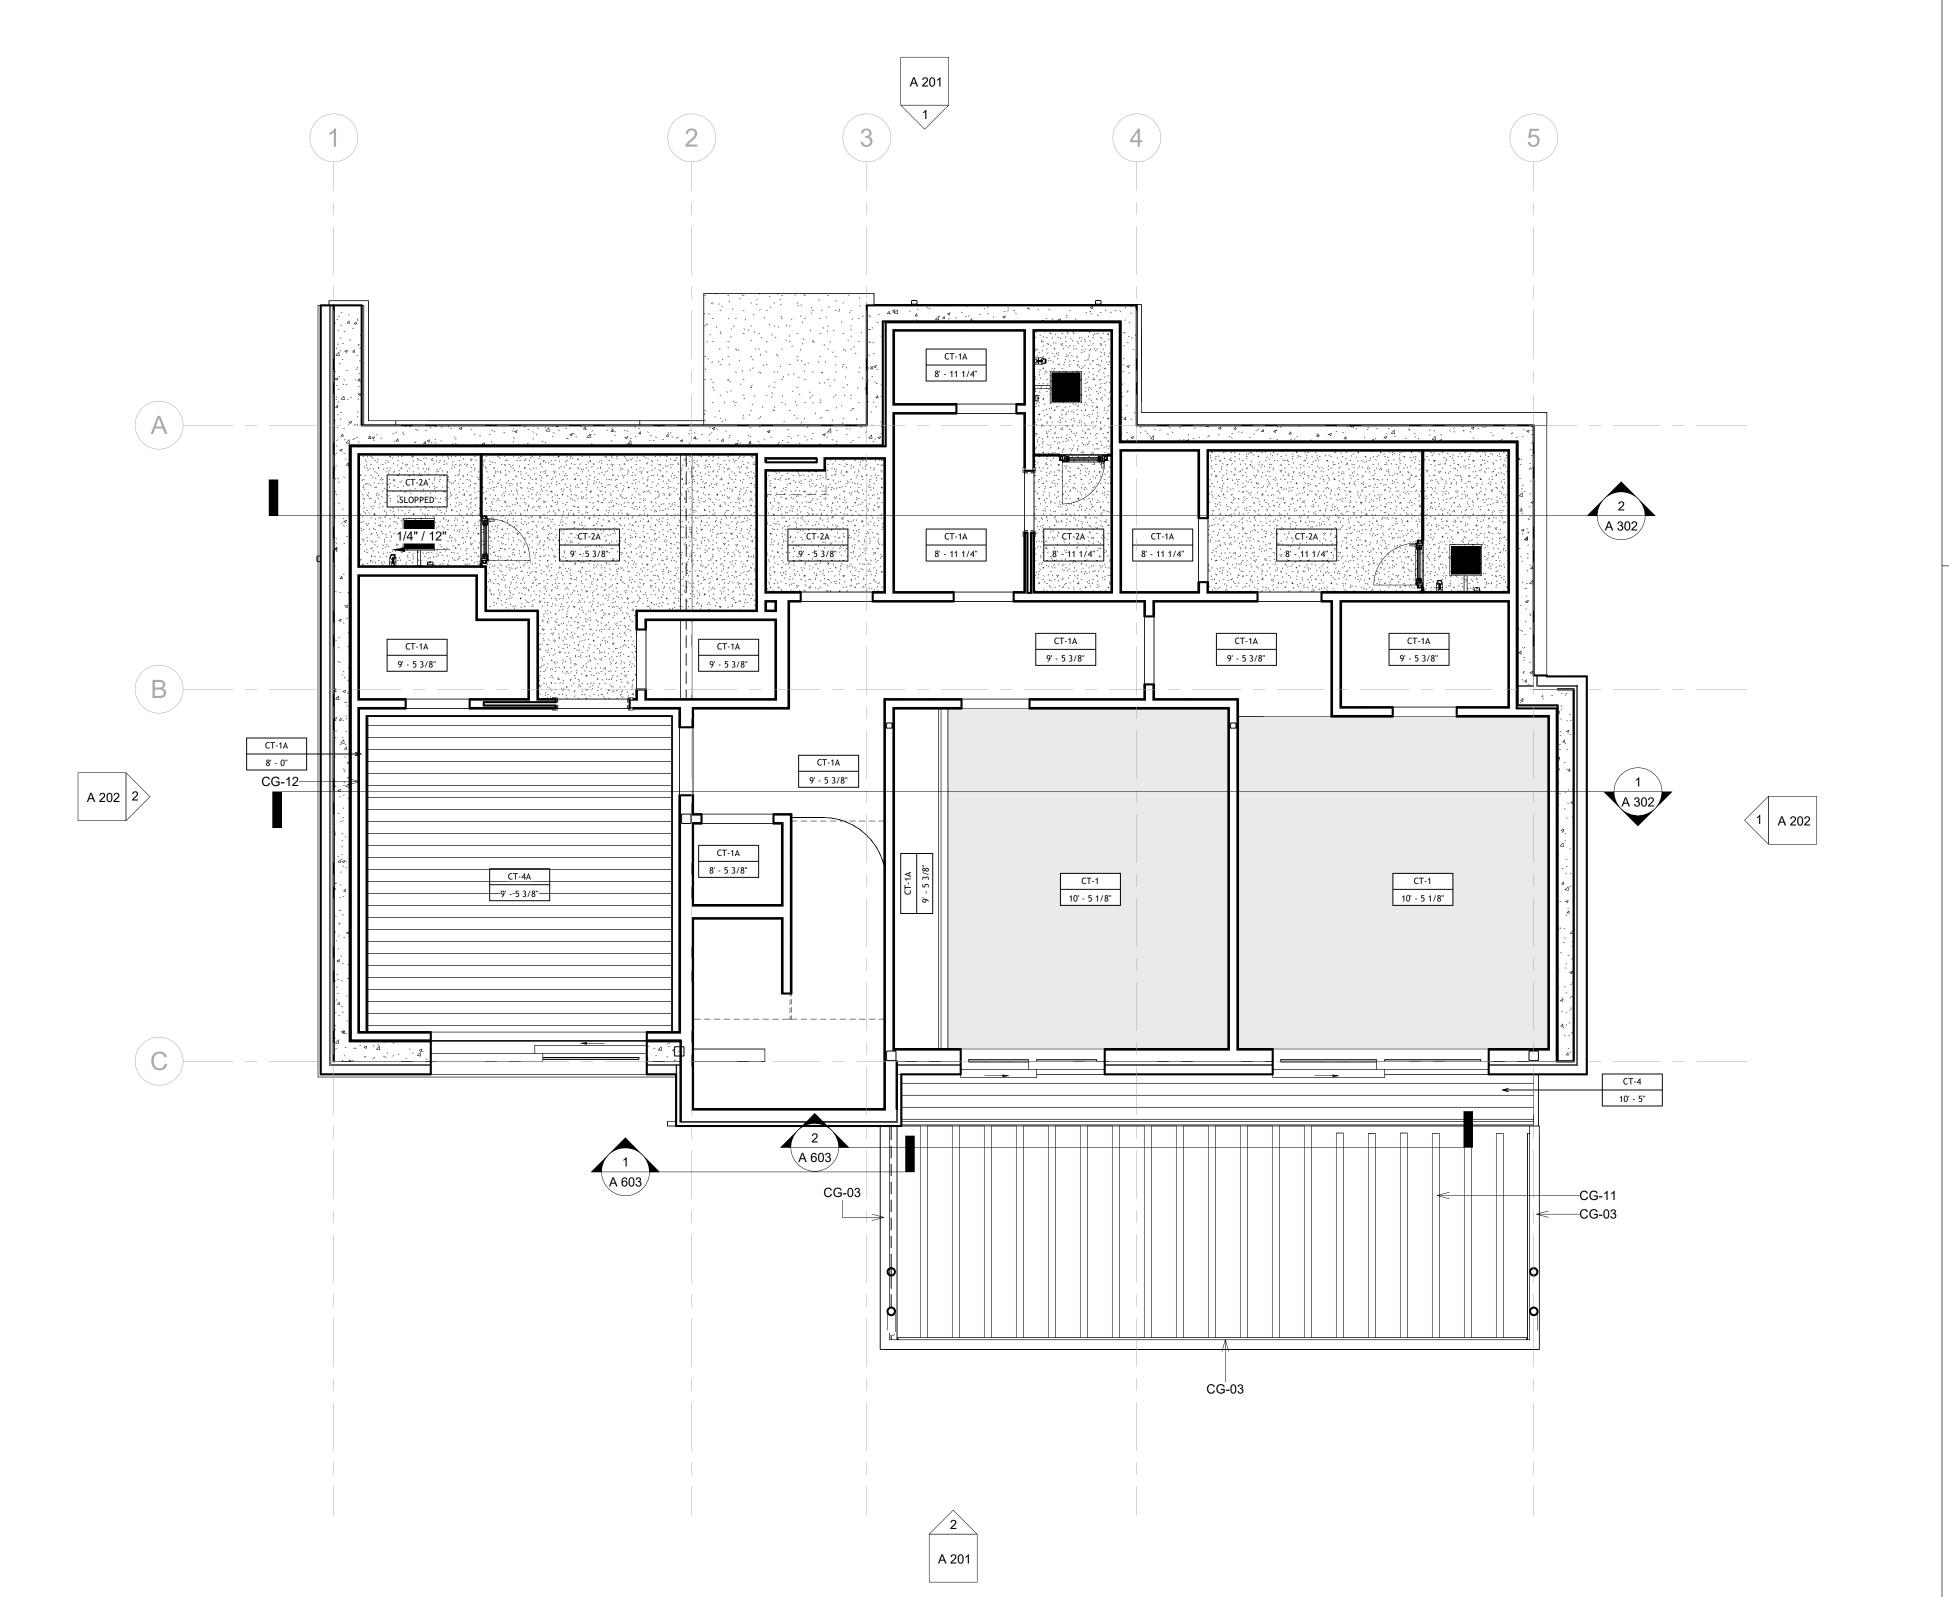

RELECTED CEILING PLAN GENERAL NOTES

- 1. ALL DIMENSIONS ARE TO INTERIOR FACE-OF-STUD (F.O.S.) UNLESS NOTED OTHERWISE.
- 2. ALL CEILING HEIGHTS MEASURED FORM TOP OF PLYWOOD OR CONCRETE SLAB TO BOTTOM OF CEILING FRAMING, U.N.O. -SEE SECTIONS
- 3. REFER TO ENLARGED PLANS FOR ALL UNITS DIMENSIONS, WINDOW TYPES, DOORS AND WALLS.
- 4. REFER TO ENLARGED PLANS FOR ALL DECKS.
- 5. COORDINATE WITH ALL ENLARGED PLANS FOR ADDITIONAL INFORMATION AND DETAILS.
- 6. SEE SHEET G002 FOR PROJECT SPECIFICATION LIST. REVIEW ALL NOTES PRIOR TO CONSTRUCTION.
- 7. COORDINATE WITH ELECTRICAL DRAWINGS FOR ALL LIGHTING, POWER AND DATA REQUIREMENTS.

8. ALL INTERIOR FINISHES ARE NOTED FOR CONCEPT ONLY. SEE INTERIOR DRAWINGS FOR MATERIAL SPECIFICATIONS. COLORS, PATTERNS, AND OTHER REQUIREMENTS PRIOR TO INSTALLATION.

CEILING TAG SYMBOL	DESCRIPTION
C1 〈	CEILING TYPE
1' - 0"	-HEIGHT


CT-4

CT-1A 10' - 11 3/8"

CT-1A 10' - 11 3/8"

7' - 3 1/2"

	R	EFLECTED CEILING PLA	N MATERIAL LEGEND		
HATCH PATTERN	TYPE	DESCRIPTION	HATCH PATTERN	TYPE	DESCRIPTION
	CT-1	5/8" GYPSUM BOARD AT FRAMING.		CT-4	WOOD CEILING AT FRAMING AS PER OWNER
	CT-1A	5/8" GYPSUM BOARD AT 2X4 DROP CEILING.			
				CT-5	EXPOSED UNDERSIDE OF DECKING
	CT-2A	5/8" WATER RESISTANT GYPSUM BOARD AT 2X4 DROP CEILING.			EXPOSED STEEL PLATE

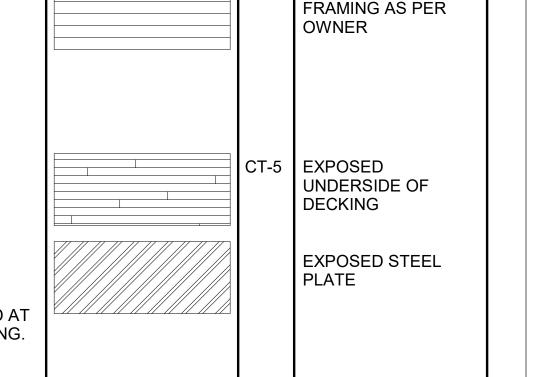

RFC 2 Key Value Keynote Text

STRUCTURAL BEAM- SEE STRUCTURAL DRAWINGS/BEAM TO BE PRIMED AND PAINTED AT ALL EXTERIOR LOCATIONS, PAINT COLOR AT ALL INTERIOR LOCATIONS PER INTERIOR DESIGN.

CG-10 STEEL PLATE AWNING. HEAVY TIMBER - SEE STRUCTURAL

CG-12 CEILING SOFFIT 4"WX6"H TO COVER STEEL BEAM



CONTRACTORS

"SOARING ABOVE YOUR EXPECTATIONS"

800 N 6th St Wahpeton, North Dakota

VALVAERE - CABIN

Emily Schmidt David Hartung Glen Erickson Logan Prochnow Chloe Lawrence Mikaela Prochnow


VALVAERE - CABIN

10226 N LIV PL, Park City, Utah


Lot C-07

LEVEL 1 CEILING PLAN


Project Number	20203284
Date	10/26/2023
Drawn By	DPH
Checked By	EES

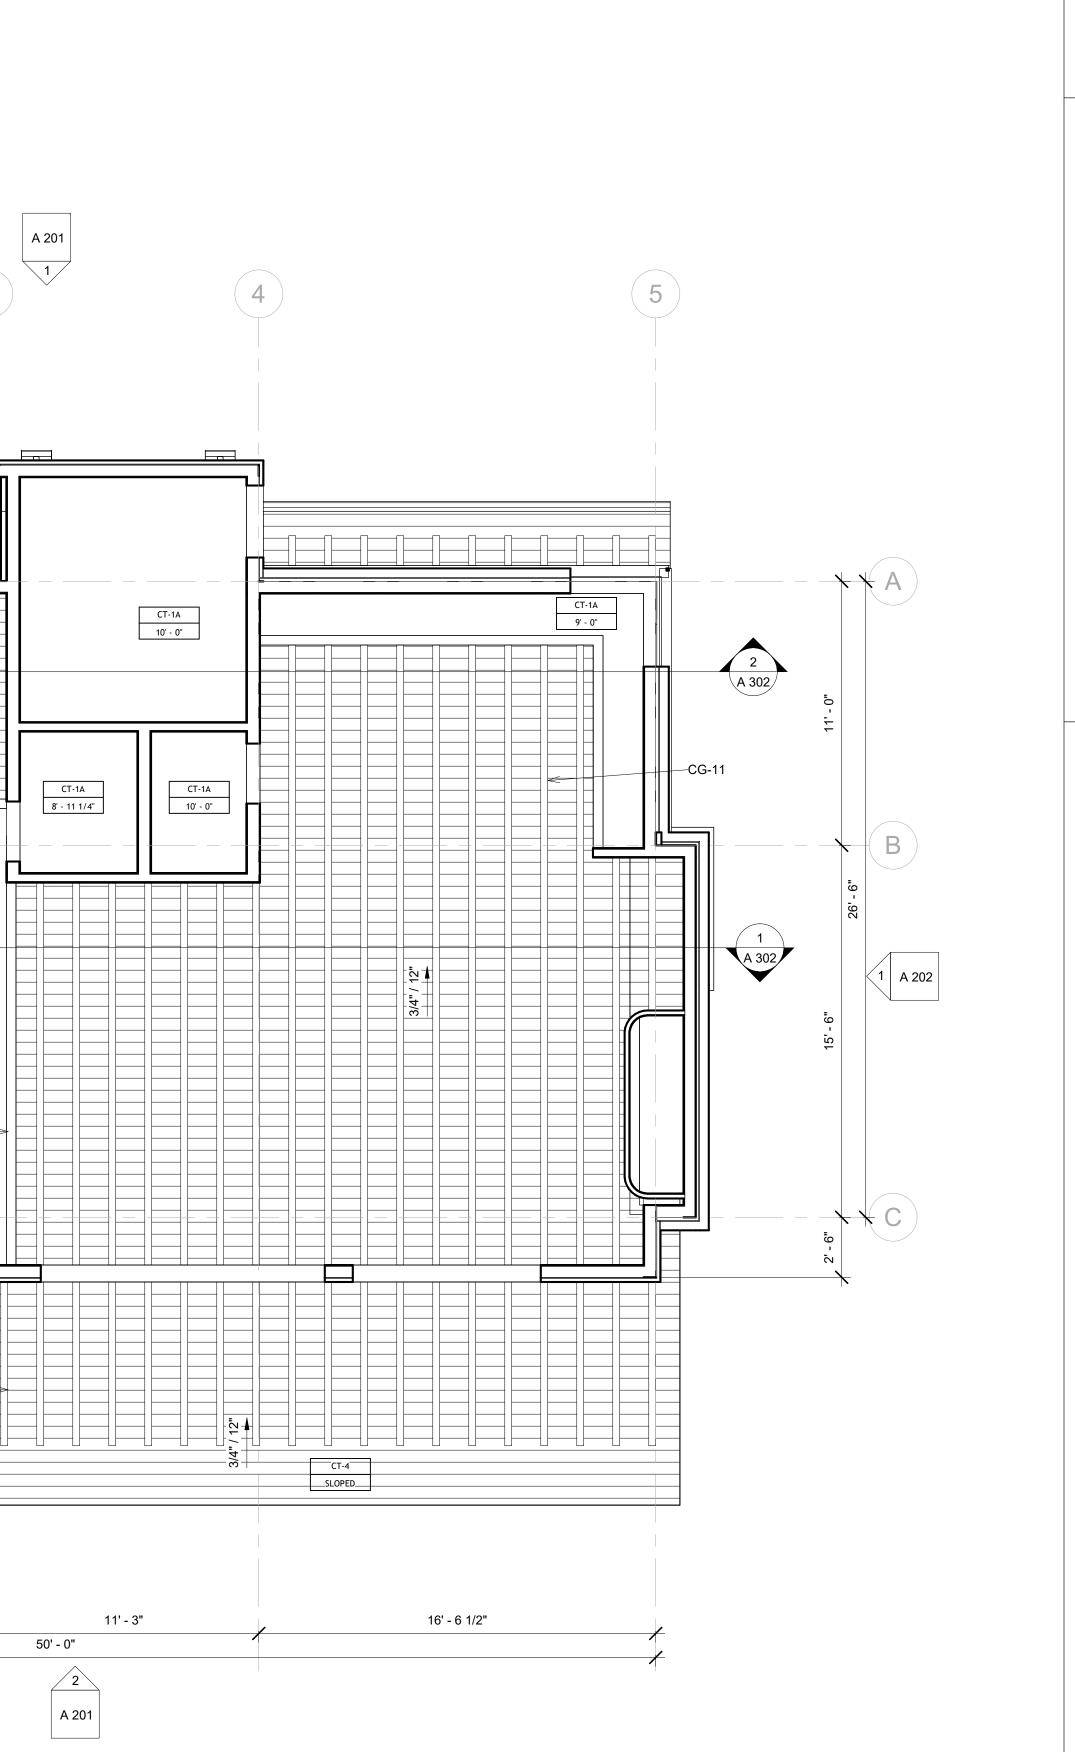

A 202 2

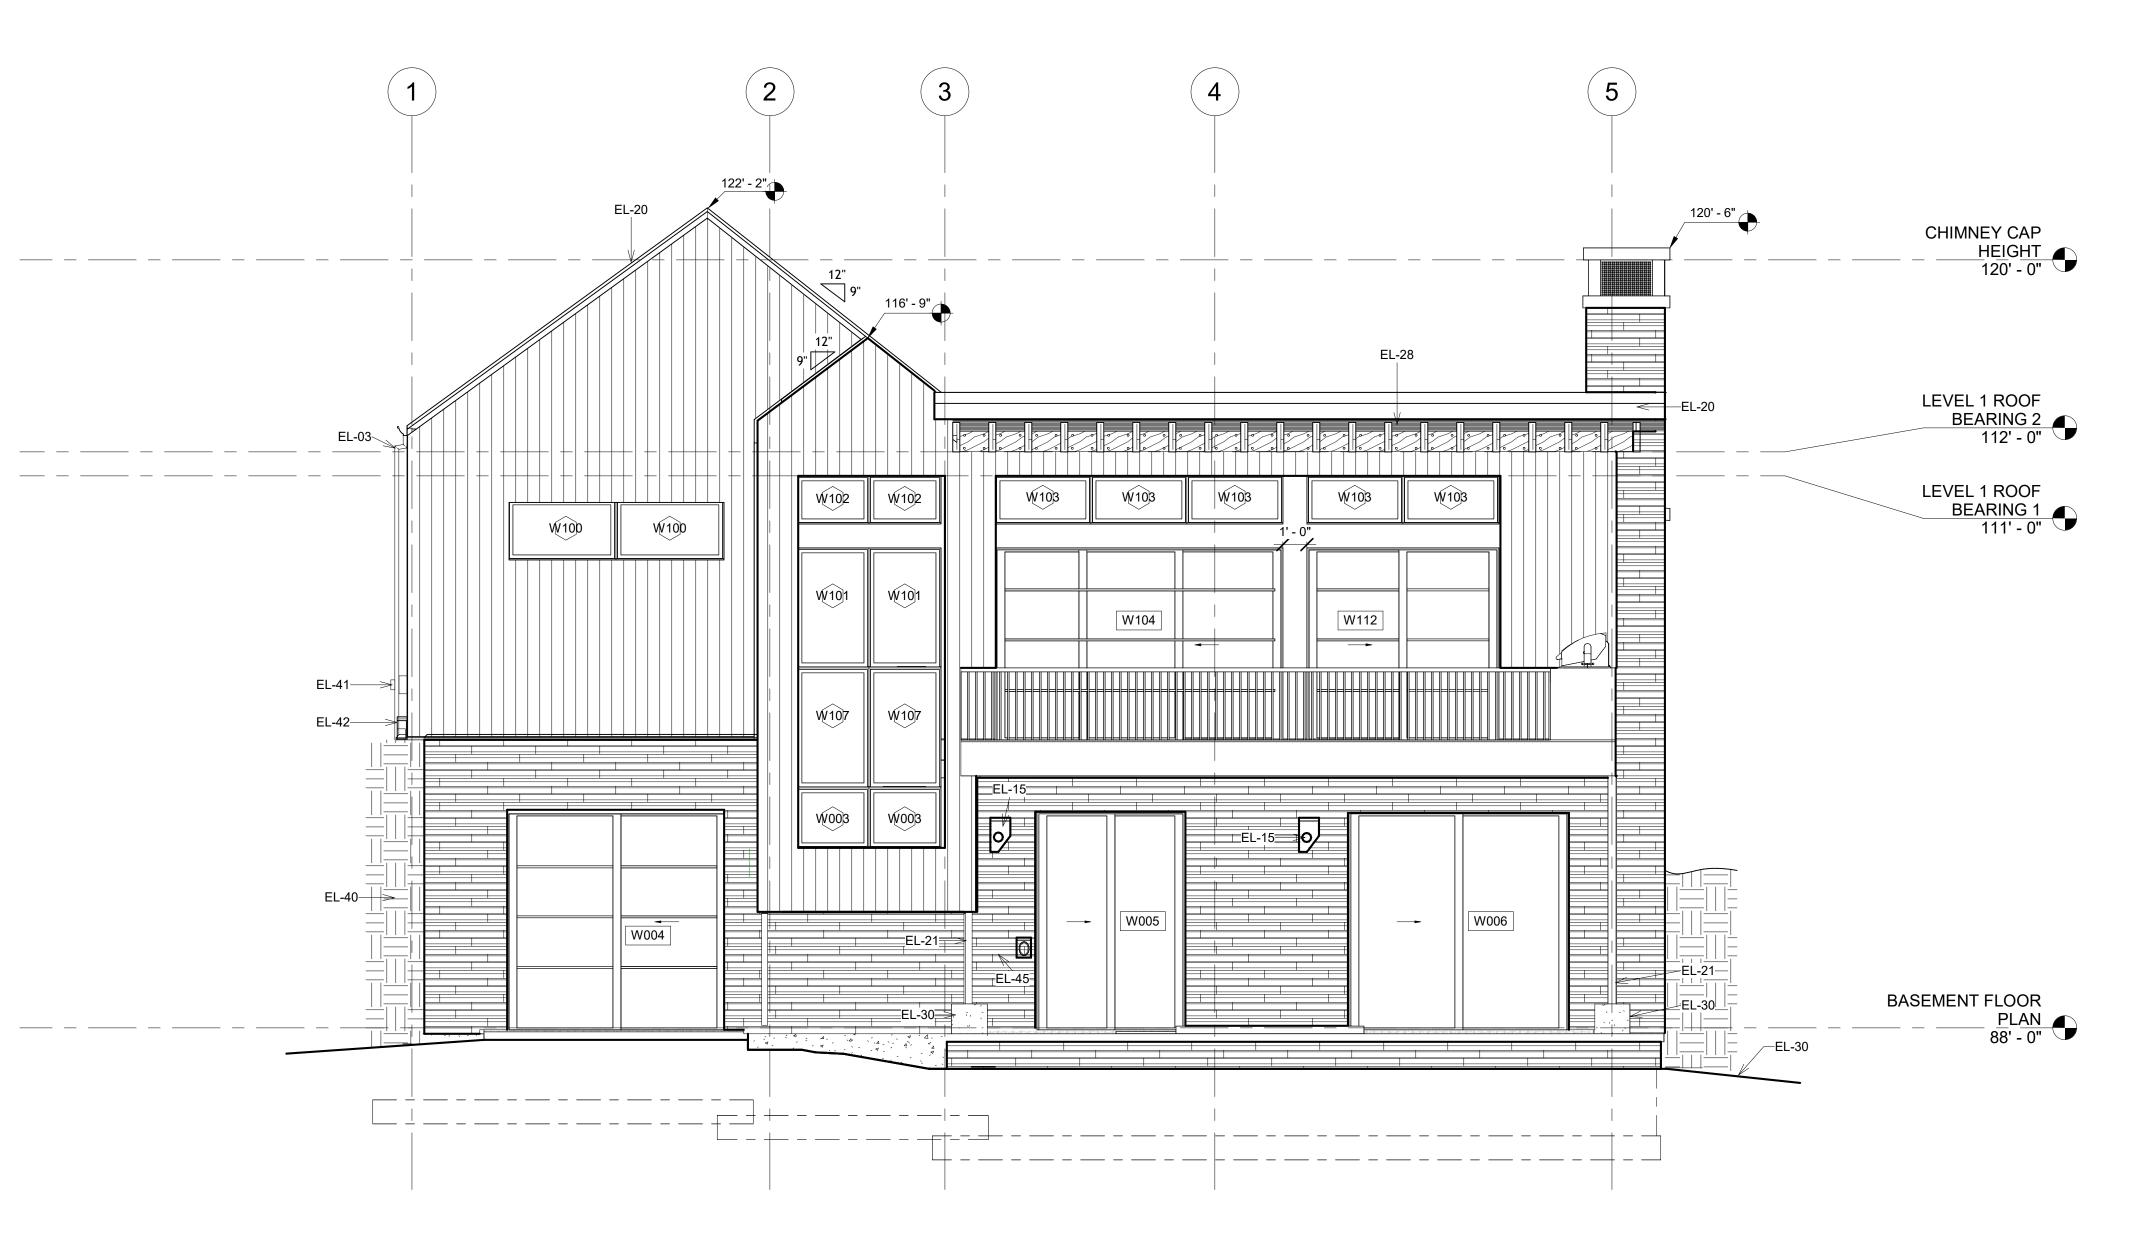

2 South
1/4" = 1'-0"

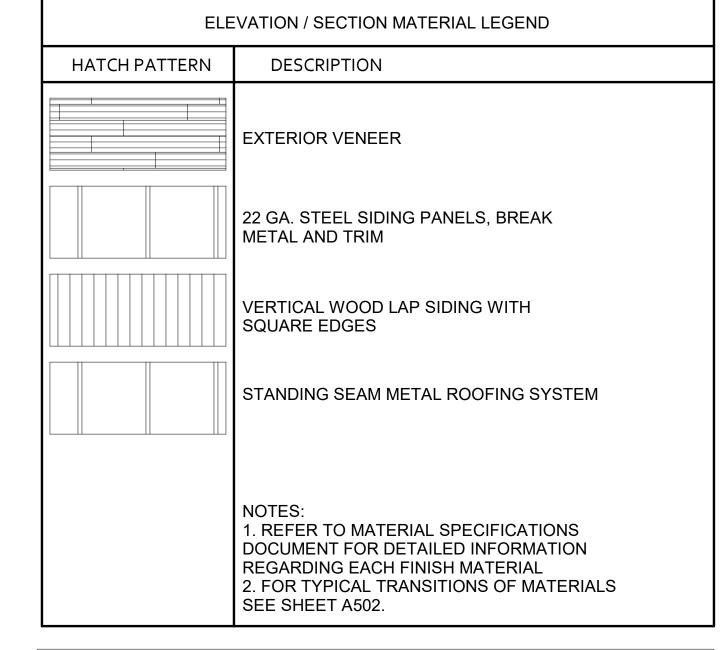

AND MAINTENANCE CLEARANCES PER MANUF.

EL-45 ELECTRICAL EQUIPMENT- SEE ELECTRICAL DRAWINGS

EL-15 EXTERIOR WALL MOUNTED LIGHT FIXTURE

HEAVY TIMBER, SEE STRUCTURAL

EL-37 BBQ-GRILL AS SELECTED BY OWNER

CONCRETE

PREFINISHED METAL FASCIA

STEEL PIPE COLUMN, SEE STRUCTURAL-TO BE PRIMED AND PAINTED AT ALL EXTERIOR LOCATIONS-PAINT COLOR PER OWNER, PAINT COLOR AT ALL INTERIOR LOCATIONS PER INTERIOR DESIGN

MECHANICAL AIR CONDITIONER UNIT- SEPARATION BETWEEN UNITS

GAS METER, INSTALLED AND COORDINATED AS REQUIRED BY UTILITY PROVIDER - PROVIDE PROTECTIVE COVER (SHOWN DASHED) AS REQUIRED BY UTILITY PROVIDER

ARCHITECTURAL GRADE CONCRETE FINISH ON ALL EXPOSED

FOR TERMINATION OF DOWNSPOUTS SEE LANDSCAPE PLANS

Key Value

		NOTES: 1. REFER TO MATERIAL SPECIFICATIONS DOCUMENT FOR DETAILED INFORMATION REGARDING EACH FINISH MATERIAL 2. FOR TYPICAL TRANSITIONS OF MATERIALS SEE SHEET A502.		
			J _	
		ELEVATIONS		
alue		Keynote Text		
	CONTRACTO	R SHALL VERIFY THAT ALL GRADE SLOPES AWAY FROM	7	
		OPE SHALL BE 6" SLOPE IN FIRST 10'-0"		
		R TO COORDINATE CAS AND ELECTRICAL METERS ON		ARCHITECTURAL MODELING & DESIGN TECHNOLOGY
		, AND COORDINATE GAS AND ELECTRICAL METERS ON D SHALL PROVIDE PROTECTION		WWW.NDSCS.EDU
		OWNSPOUT TO STORM DRAIN CONNECTION AT GRADE.		800 N 6th St
		ANS FOR HOOKUP		
		ALL MOUNTED LIGHT FIXTURE		Wahpeton, North Dakota

VALVAERE - CABIN

CONTRACTORS

"SOARING ABOVE YOUR EXPECTATIONS"

Emily Schmidt David Hartung Glen Erickson Logan Prochnow Chloe Lawrence Mikaela Prochnow

CHIMNEY CAP LEVEL 1 ROOF

BEARING 2

112' - 0" LEVEL 1 ROOF
BEARING 1
111' - 0" W105 FIRST FLOOR


VALVAERE - CABIN


10226 N LIV PL, Park City, Utah


Lot C-07


EXTERIOR ELEVATIONS

Project Number	20203284
Date	10/26/2023
Drawn By	EES
Checked By	DPH

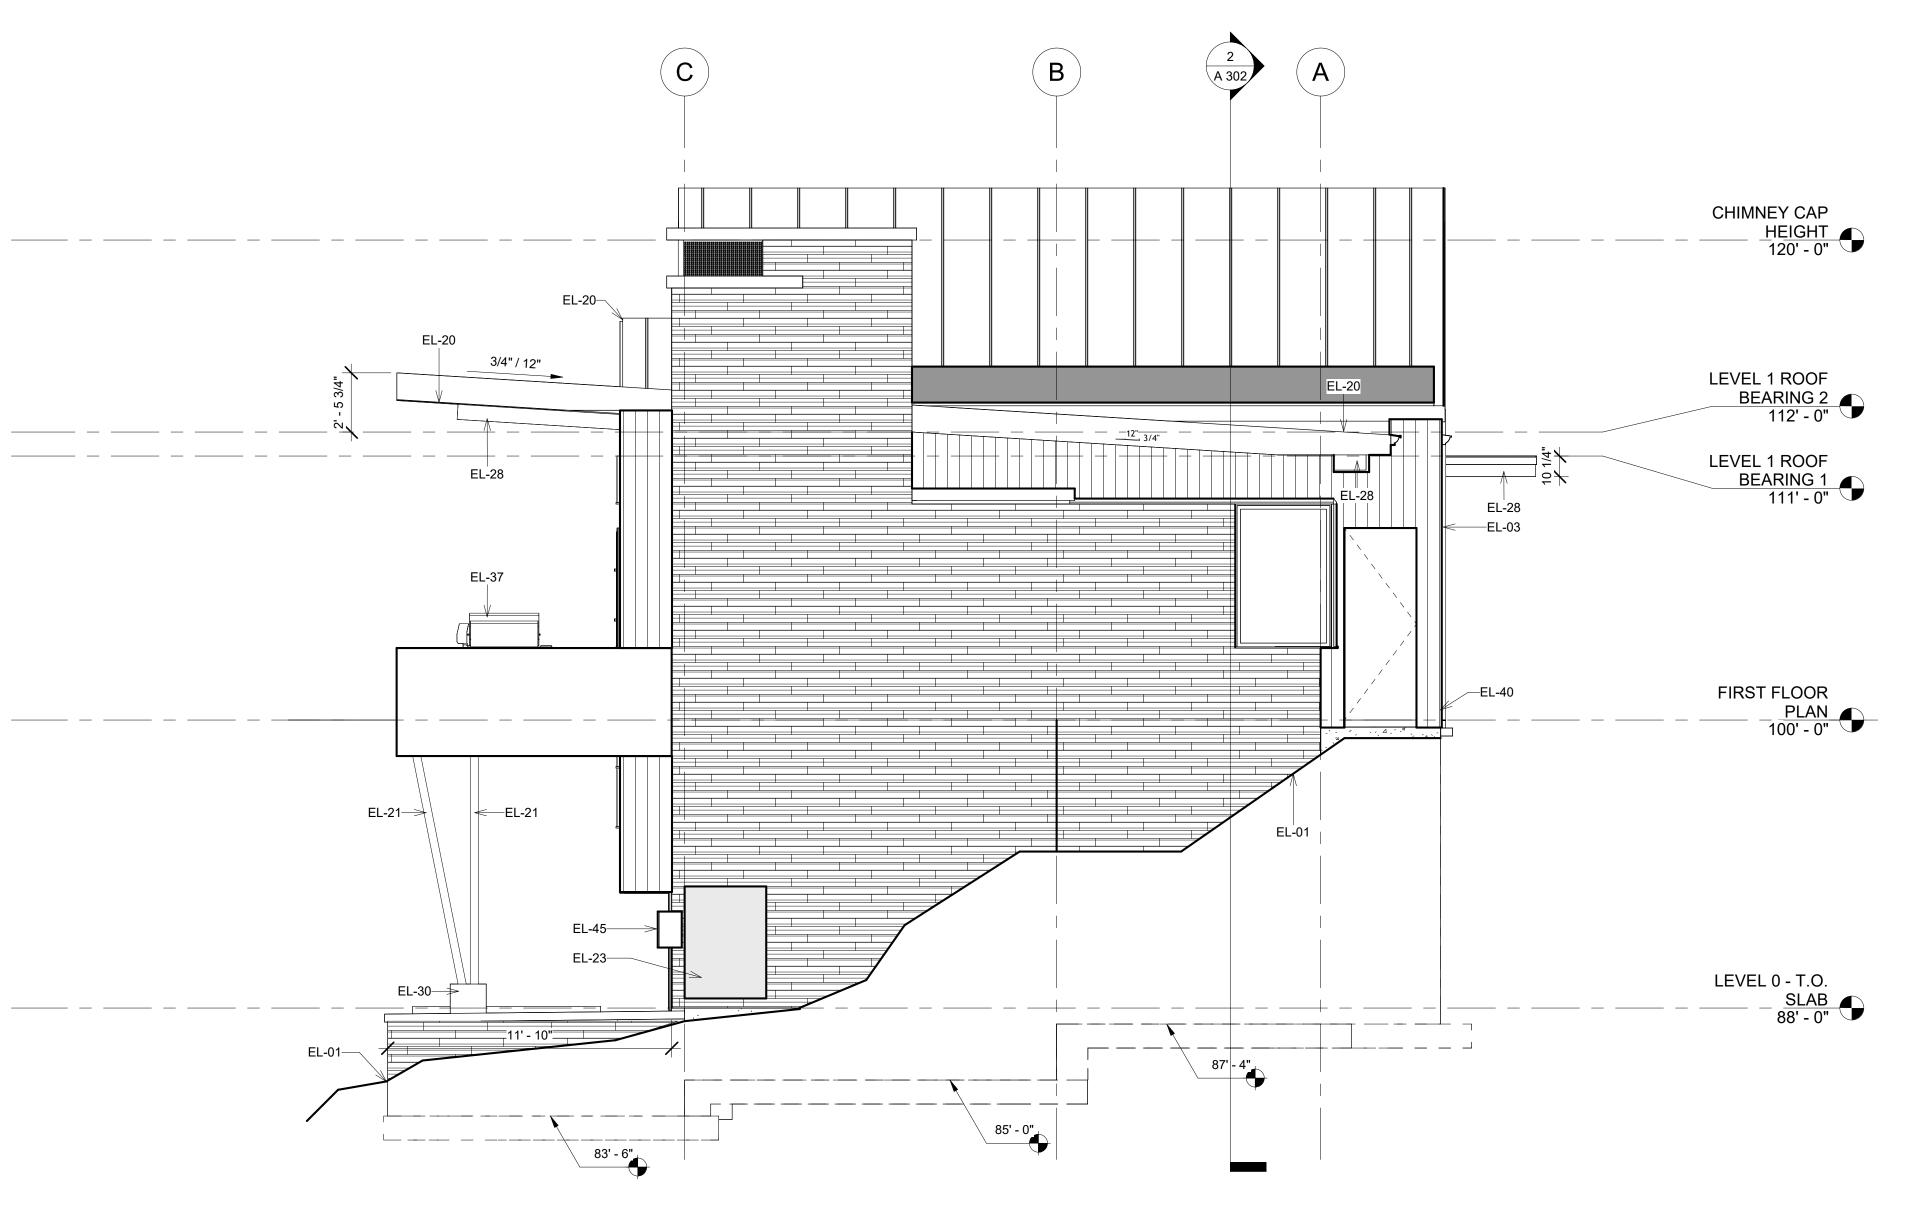

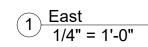

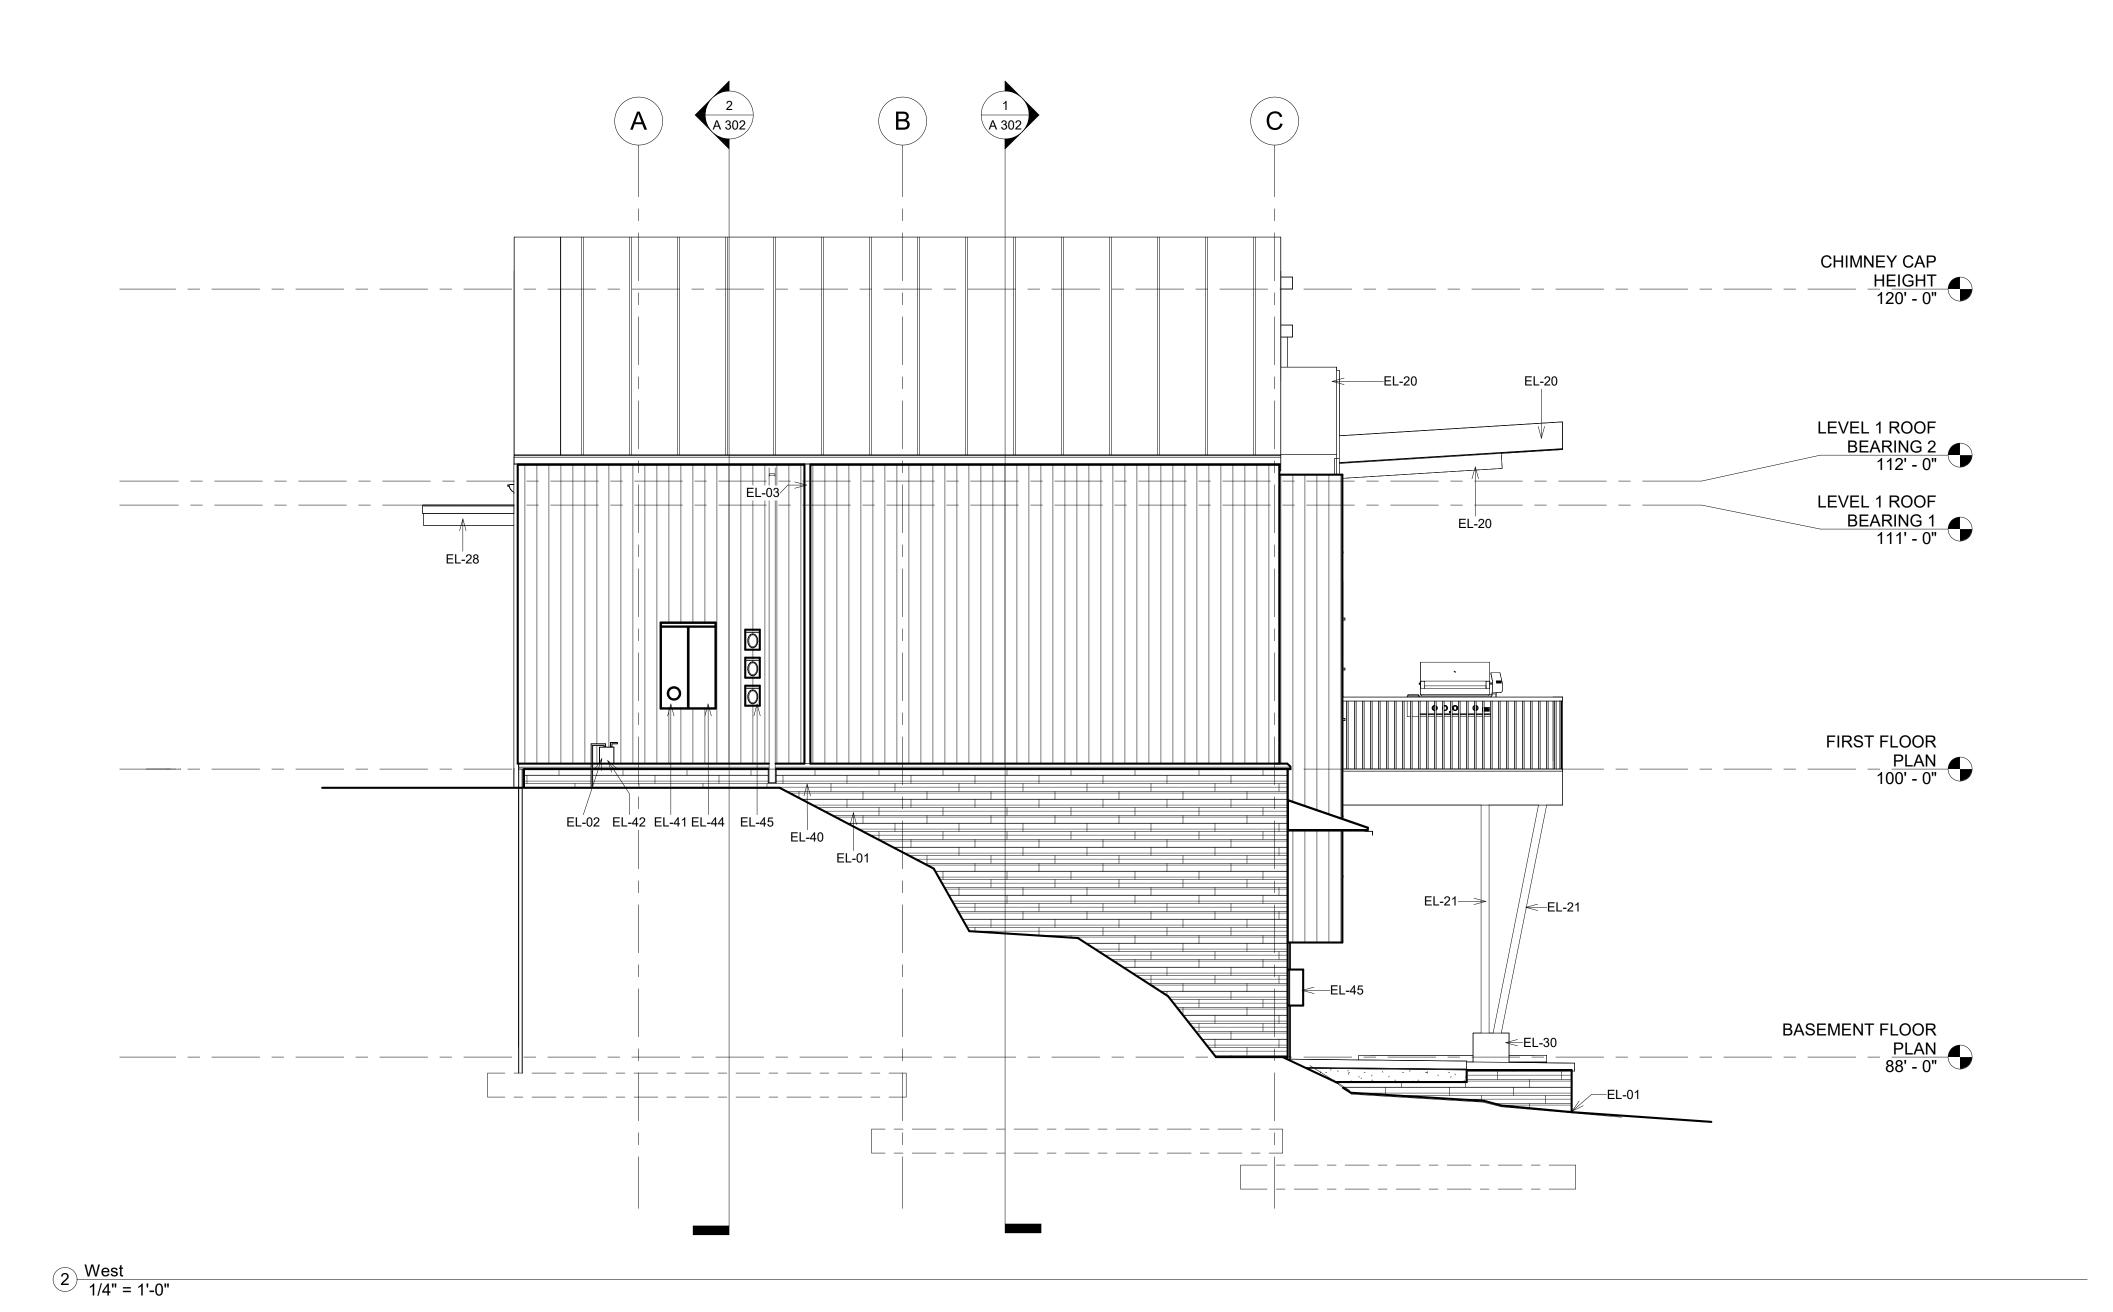

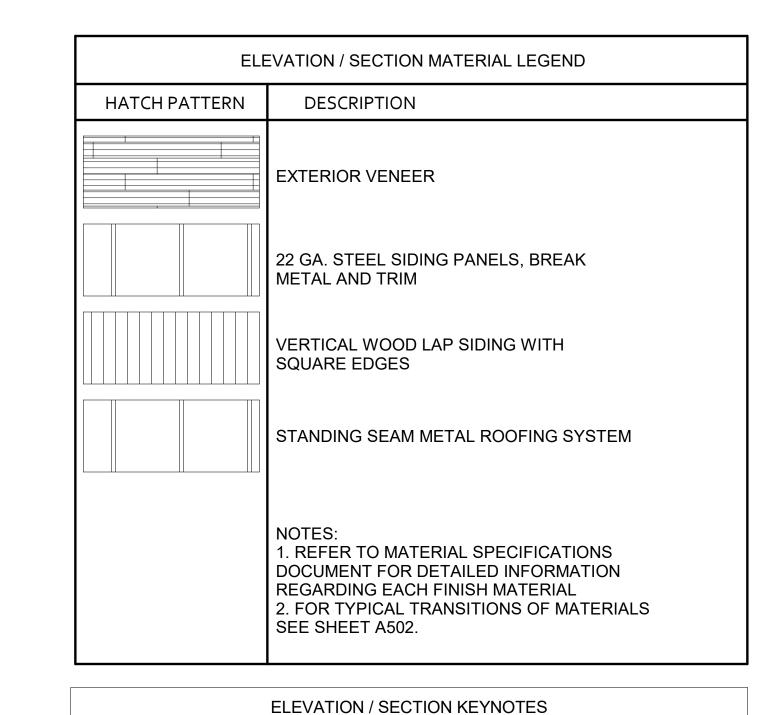

Key Value	Keynote Text			
EL-01	CONTRACTOR SHALL VERIFY THAT ALL GRADE SLOPES AWAY FROM BUILDNG. SLOPE SHALL BE 6" SLOPE IN FIRST 10'-0"			
EL-02	CONTRACTOR TO COORDINATE WITH CIVIL DRAWINGS FOR LOCATION OF UTILITIES, AND COORDINATE GAS AND ELECTRICAL METERS ON BUILDING AND SHALL PROVIDE PROTECTION			
EL-03	CONNECT DOWNSPOUT TO STORM DRAIN CONNECTION AT GRADE. SEE CIVIL PLANS FOR HOOKUP			
EL-15	EXTERIOR WALL MOUNTED LIGHT FIXTURE			
EL-20	PREFINISHED METAL FASCIA			
EL-21	STEEL PIPE COLUMN, SEE STRUCTURAL-TO BE PRIMED AND PAINTED AT ALL EXTERIOR LOCATIONS-PAINT COLOR PER OWNER, PAINT COLOR AT ALL INTERIOR LOCATIONS PER INTERIOR DESIGN			
EL-23	MECHANICAL AIR CONDITIONER UNIT- SEPARATION BETWEEN UNITS AND MAINTENANCE CLEARANCES PER MANUF.			
EL-28	HEAVY TIMBER, SEE STRUCTURAL			
EL-30 ARCHITECTURAL GRADE CONCRETE FINISH ON ALL EXPOSED CONCRETE				
EL-37	BBQ-GRILL AS SELECTED BY OWNER			
EL-40	FOR TERMINATION OF DOWNSPOUTS SEE LANDSCAPE PLANS			
EL-41	ELECTRICAL - MAIN ELECTRICAL PANEL WITH METER - INSTALLED AND COORDINATED AS REQUIRED BY UTILITY PROVIDER- SEE ELECTRICAL			
EL-42 GAS METER, INSTALLED AND COORDINATED AS REQUIRED BY UT PROVIDER - PROVIDE PROTECTIVE COVER (SHOWN DASHED) AS REQUIRED BY UTILITY PROVIDER				
EL-44	PROVIDE A U-FER GROUND. AN ELECTRODE ENCASED BY AT LEAST 2" OF CONCRETE-SHALL BE LOCATED NEAR THE BOTTOM OF THE CONCRETE FOUNDATION SYSTEM AND SHALL BE IN DIRECT CONTACT WITH THE EARTH, CONSISTING OF AT LEAST 20 FEET OF BARE ELECTRICALLY CONDUCTIVE ROD AT LEAST 1/2 INCH IN DIAMETER OR BARE COPPER CONDUCTOR NOT SMALLER THAN 4 AWG.(I.R.C.E3508.1.2 AND N.E.C.250.50)			
EL-45	ELECTRICAL EQUIPMENT- SEE ELECTRICAL DRAWINGS			





VALVAERE - CABIN B

Emily Schmidt
David Hartung
Glen Erickson
Logan Prochnow
Chloe Lawrence
Mikaela Prochnow

VALVAERE - CABIN B

10226 N LIV PL, Park City, Utah


Lot C-07


EXTERIOR ELEVATIONS

10/26/2023
EES
DPH


1 202


AZUZ

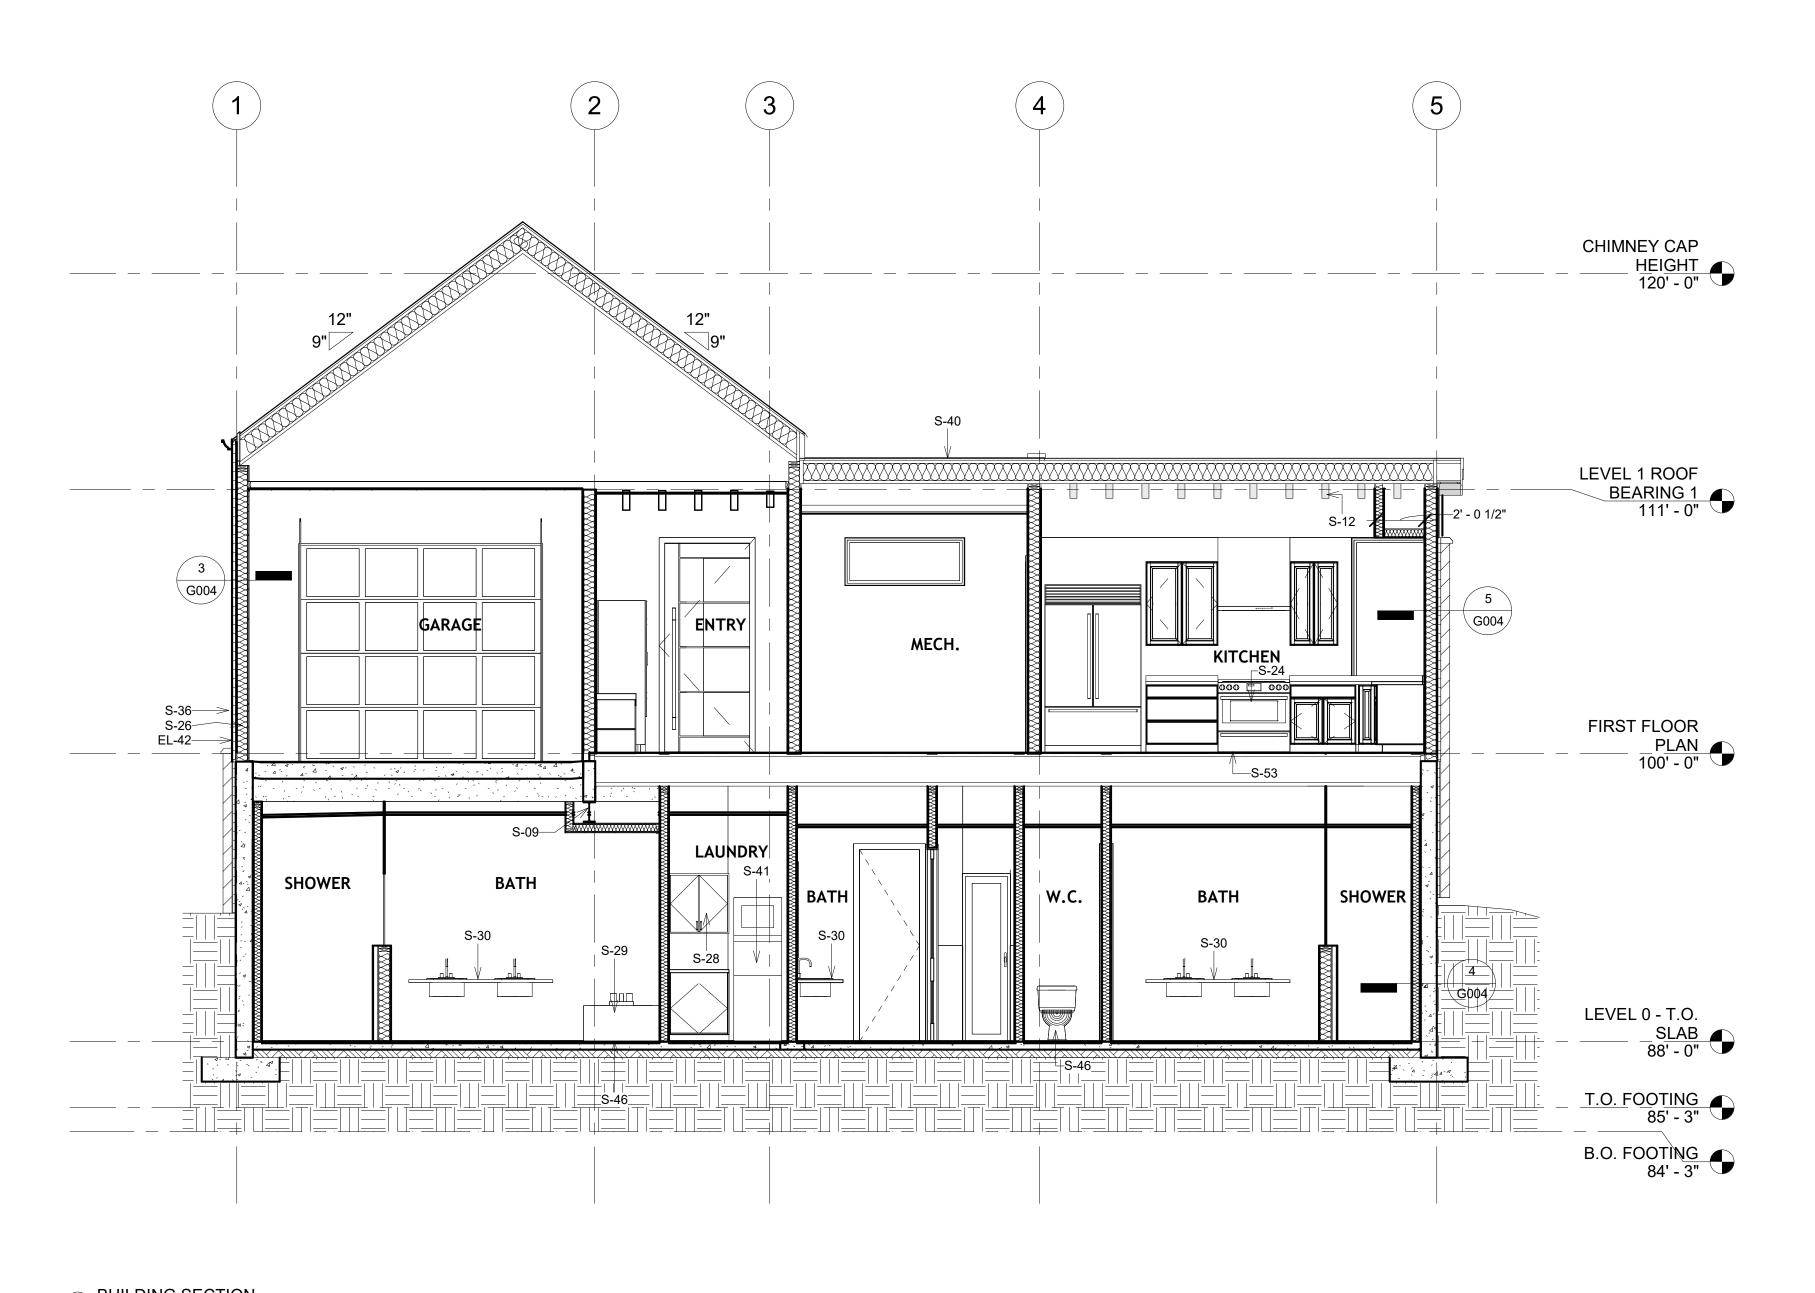

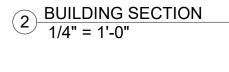


1 BUILDING SECTION 1/4" = 1'-0"

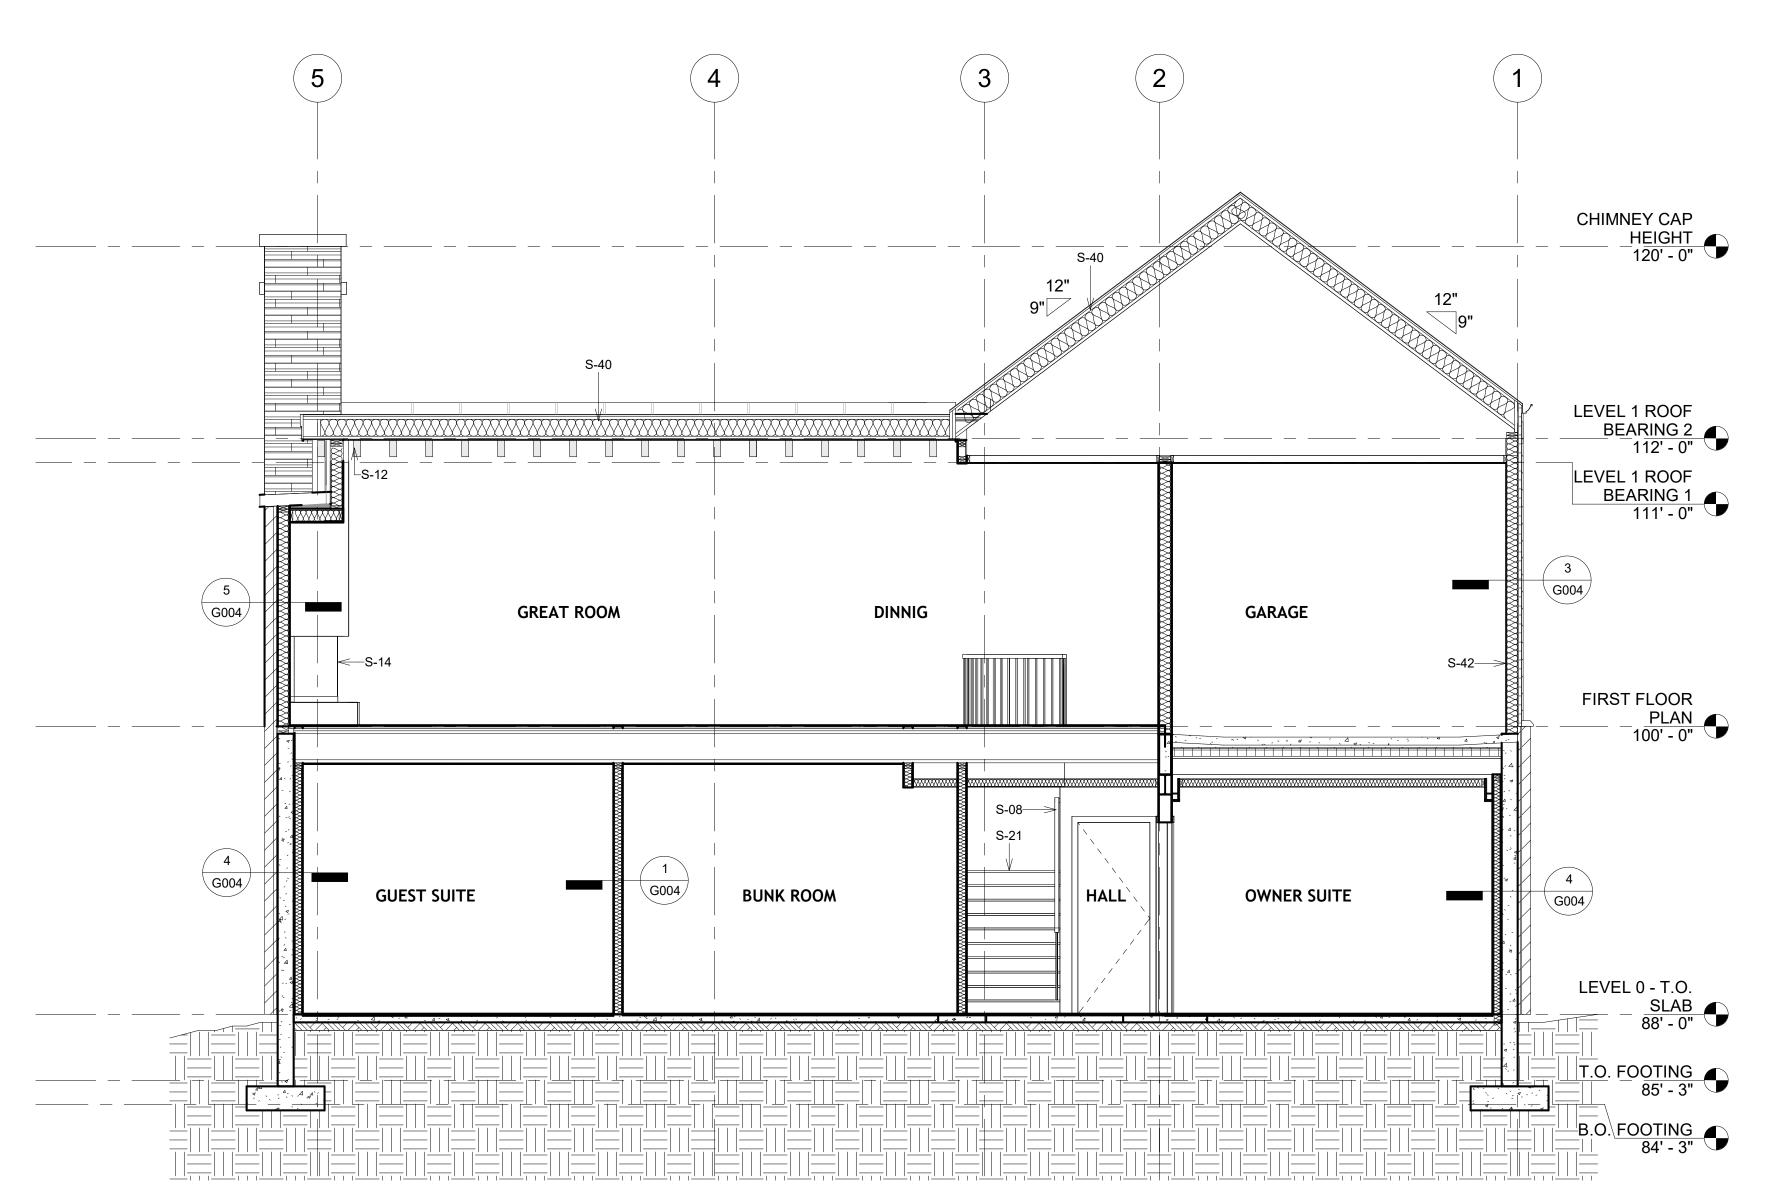

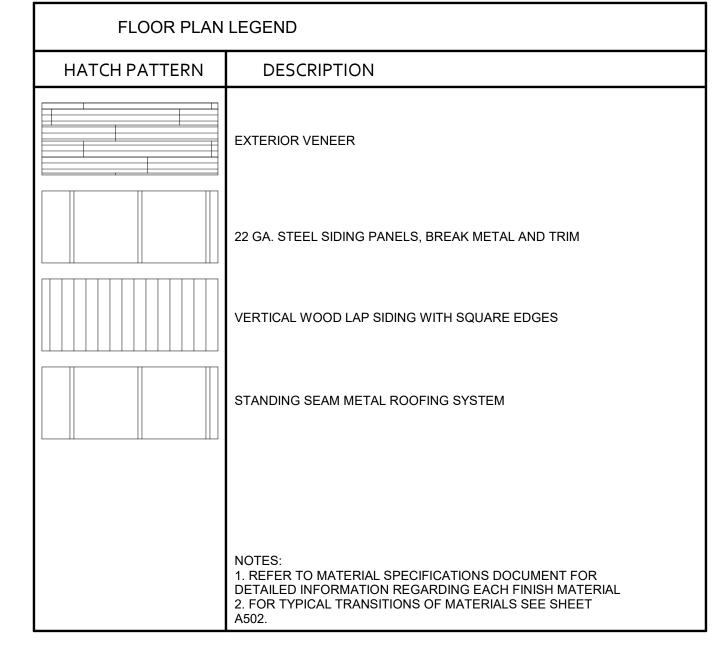



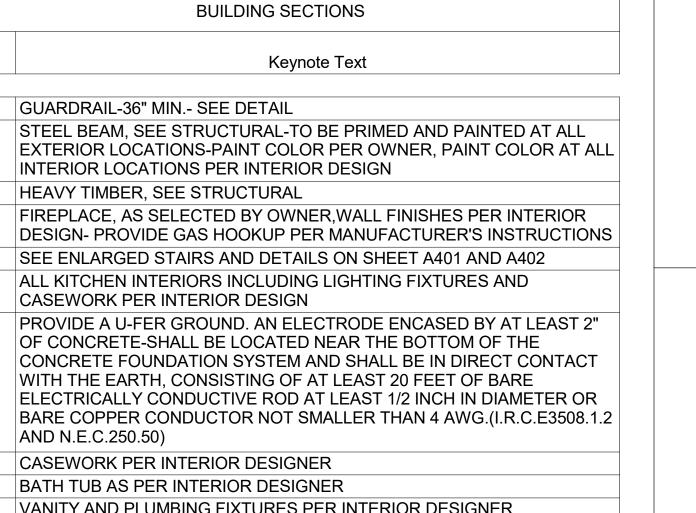

-29 BATH TUB AS PER INTERIOR DESIGNER
-30 VANITY AND PLUMBING FIXTURES PER INTERIOR DESIGNER
-36 ELECTRICAL - MAIN ELECTRICAL PANEL WITH METER - INSTALLED AND COORDINATED AS REQUIRED BY UTILITY PROVIDER- SEE ELECTRICAL PLANS
-38 PROVIDE 100% SOLIDS EPOXY, HIGH PERFORMANCE COATING
-40 CAVITY INSULATION PER SCHEDULE
-41 STACKABLE WASHER/ DRYER. COORDINATE W/ INTERIOR DESIGNER & CONSTRUCTION TRADES AS REQUIRED
-42 WALL MOUNTED SKI RACK
-46 CONTRACTOR TO COORDINATE LOCATION OF PLUMBING FIXTURES WITH PLANS AND IN THE FIELD PRIOR TO POURING CONCRETE SLAB-SETTING BED TO PROVIDE SLOPE

CONTRACTOR TO COORDINATE LOCATION OF PLUMBING FIXTURES WITH PLANS AND IN THE FIELD TO PROVIDE SLOPE AND/OR FIRESTOP

BLOCKING/CAULKING AS REQUIRED

ARCHITECTURAL MODELING & DESIGN TECHNOLOGY
WWW.NDSCS.EDU

800 N 6th St Wahpeton, North Dakota

VALVAERE - CABIN B

Emily Schmidt
David Hartung
Glen Erickson
Logan Prochnow
Chloe Lawrence
Mikaela Prochnow

VALVAERE - CABIN B

10226 N LIV PL, Park City, Utah

Lot C-07

BUILDING SECTIONS

Project Number	20203284
Date	10/26/2023
Drawn By	EES
Checked By	DPH

A 302

e:





800 N 6th St

VALVAERE - CABIN

Emily Schmidt David Hartung Glen Erickson Logan Prochnow Chloe Lawrence Mikaela Prochnow

VALVAERE - CABIN

10226 N LIV PL, Park City, Utah

Lot C-07

ROOF DETAILS




As indicated


Scale:


Wahpeton, North Dakota


ROOFING UNDERLAYMENT - SEE

PROJECT SPECIFICATIONS.

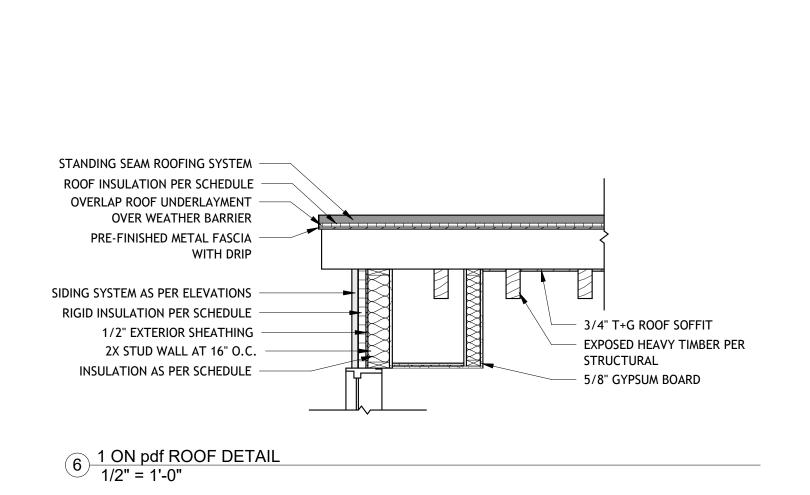


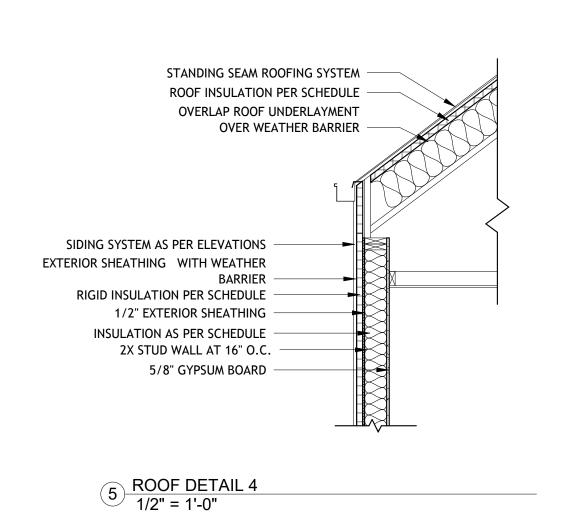

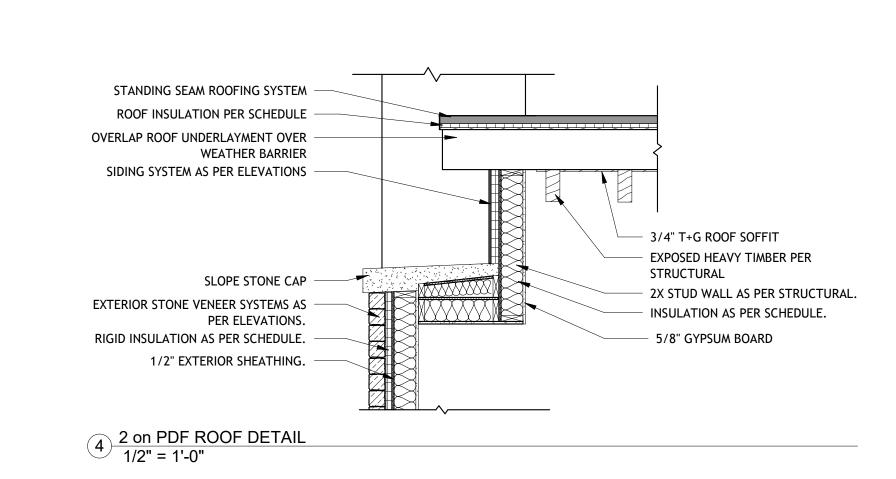


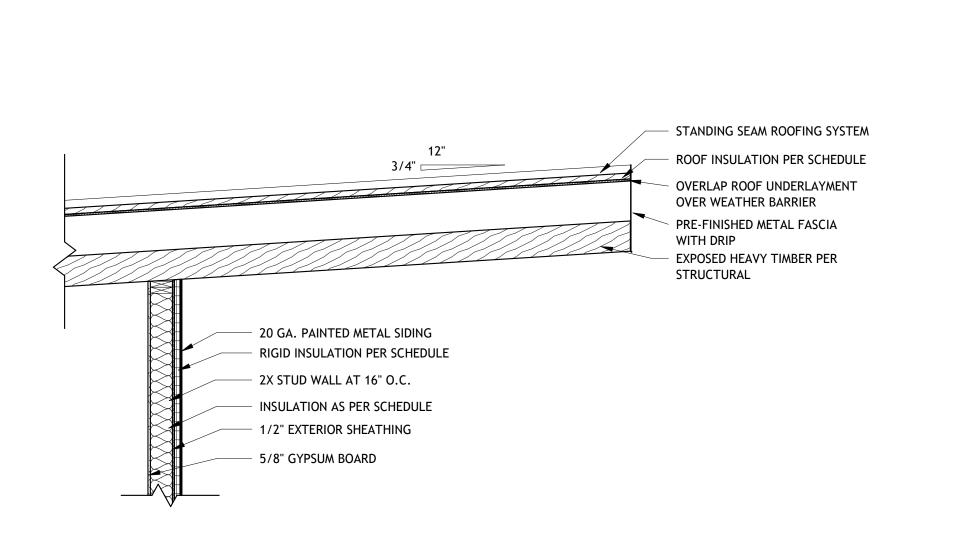

3 ROOF DETAIL 5 1/2" = 1'-0"

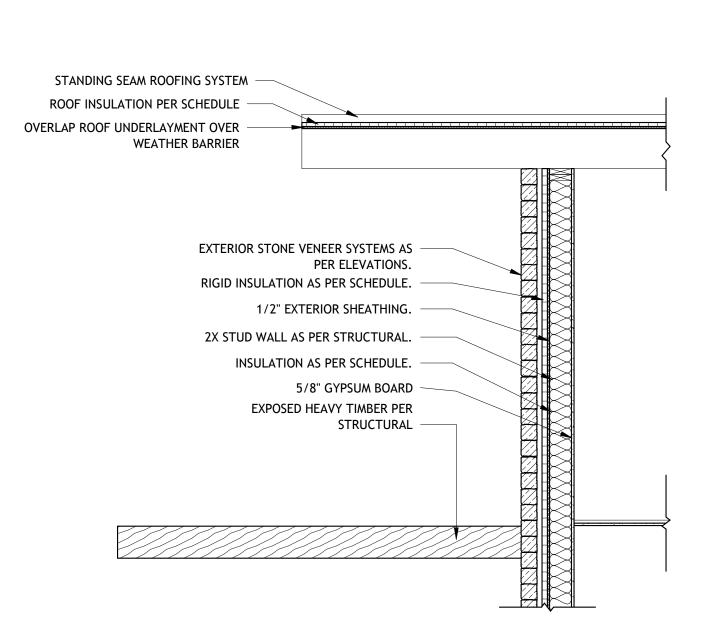

2 ROOF DETAIL 3 1/2" = 1'-0"

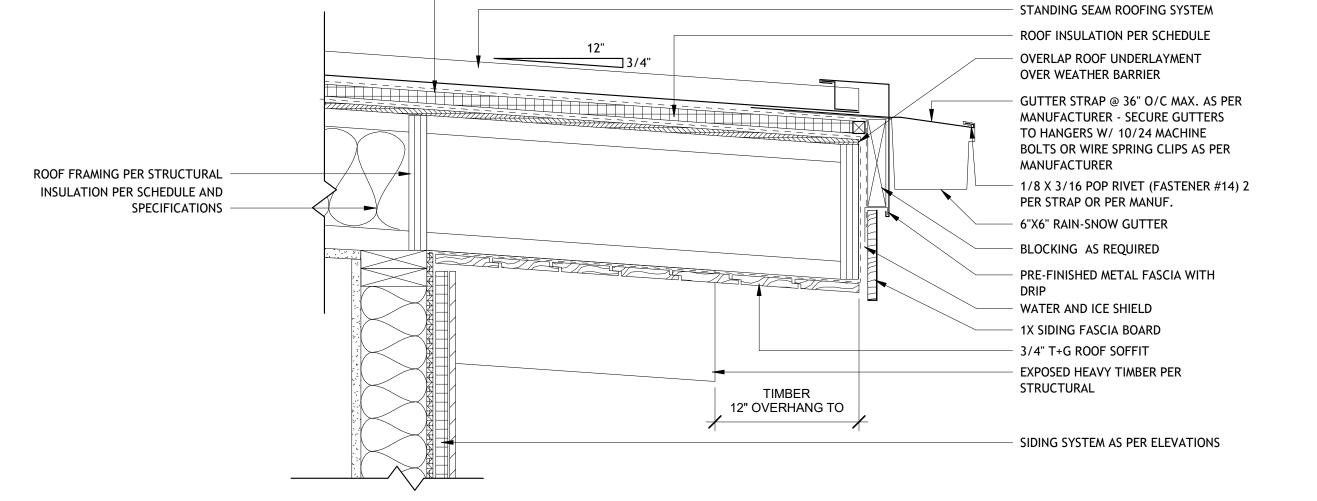

1 ROOF EAVE DETAIL AT LOW 1 1/2" = 1'-0"

							DOOR SO	CHEDULE				
	DOOR											
		SIZE					FRAME					
MARK	WIDTH	HEIGHT	THICKNESS	MATERIAL	TYPE	FINISH	MATERIAL	TYPE	FINISH	FIRE RATING	HARDWARE	REMARKS
D001A	3' - 0"	8' - 0"	2 1/4"	WOOD	D2	PER I.D.	PER I.D.	F1	PER I.D.	NON-RATED	H5	
D001B	3' - 0"	8' - 0"	2 1/4"	WOOD	D2	PER I.D.	PER I.D.	F1	PER I.D.	NON-RATED	H5	USE CUSTOM THRESHOLD AND SEAL
D002A	2' - 10"	8' - 0"	2 1/4"	WOOD	D2	PER I.D.	PER I.D.	F1	PER I.D.	NON-RATED	H8	
D002B	3' - 0"	8' - 0"	1 1/2"	WOOD	D3	PER I.D.	WOOD	F1	PER I.D.	NON-RATED	H12	POCKET DOOR
D002C	2' - 6"	8' - 0"	2 1/4"	WOOD	D2	PER I.D.	WOOD	F1	PER I.D.	NON-RATED	H8	
D002D	2' - 0"	7' - 0"	3/8"	GLASS	D4	PER I.D.	PER I.D.	PER I.D.	PER I.D.	NON-RATED	PER I.D.	TEMPERED GLASS AS PER INTERIOR DESIGN
D002E	2' - 8"	8' - 0"	2 1/4"	WOOD	D2	PER I.D.	WOOD	F1	PER I.D.	NON-RATED	H5	
D003A	2' - 10"	8' - 0"	2 1/4"	WOOD	D2	PER I.D.	WOOD	F1	PER I.D.	NON-RATED	H8	
D003B	2' - 6"	8' - 0"	2 1/4"	WOOD	D2	PER I.D.	WOOD	F1	PER I.D.	NON-RATED	H8	
D003C	2' - 6"	8' - 0"	1 1/2"	WOOD	D3	PER I.D.	WOOD	F1	PER I.D.	NON-RATED	H12	POCKET DOOR
D003D	2' - 0"	7' - 0"	3/8"	GLASS	D4	PER I.D.	PER I.D.	PER I.D.	PER I.D.	NON-RATED	PER I.D.	TEMPERED GLASS AS PER INTERIOR DESIGN
D003E	2' - 6"	8' - 0"	2 1/4"	WOOD	D2	PER I.D.	WOOD	F1	PER I.D.	NON-RATED	H8	
D004A	2' - 10"	8' - 0"	2 1/4"	WOOD	D2	PER I.D.	WOOD	F1	PER I.D.	NON-RATED	H8	
D004B	2' - 8"	8' - 0"	2 1/4"	WOOD	D2	PER I.D.	WOOD	F1	PER I.D.	NON-RATED	H8	
D004C	2' - 8"	8' - 0"	2 1/4"	WOOD	D2	PER I.D.	WOOD	F1	PER I.D.	NON-RATED	H8	
D004D	2' - 0"	7' - 0"	3/8"	GLASS	D4	PER I.D.	PER I.D.	PER I.D.	PER I.D.	NON-RATED	PER I.D.	TEMPERED GLASS AS PER INTERIOR DESIGN
D004E	2' - 8"	8' - 0"	2 1/4"	WOOD	D2	PER I.D.	WOOD	F1	PER I.D.	NON-RATED	H5	
D100A	4' - 0"	9' - 0"	3 1/32"	WOOD/METAL	D5	PER OWNER	METAL		PER OWNER	NON-RATED	H10	VELVAERE ENTRY DOOR
D100B	2' - 6"	8' - 0"	2 1/4"	WOOD	D2	PER I.D.	WOOD	F1	PER I.D.	NON-RATED	H8	
D100C	2' - 6"	8' - 0"	2 1/4"	WOOD	D2	PER I.D.	WOOD	F1	PER I.D.	NON-RATED	H5	
D101A	10' - 0"	9' - 0"	2 3/4"	PER MANUF.	D6	PER OWNER	METAL		PER OWNER	NON-RATED	H2	GARAGE DOOR PER OWNER
D101B	3' - 0"	8' - 0"	2 1/4"	WOOD	D1	PER I.D.	WOOD	F1	PER I.D.	20 MIN.	H4	GARAGE TO LIVING SPACES
D107A	3' - 0"	8' - 0"	2 1/4"	WOOD	D1	PER OWNER	WOOD	F1	PER OWNER	NON-RATED	H4	MECH. ROOM EXTERIOR

	WINDOW SCHEDULE									
	UNIT SIZE						GLAZ			
MARK	WIDTH	HEIGHT	HEAD HEIGHT	OPERATION	MATERIAL	FINISH	THICKNESS	TYPE	COMMENTS	
W003	3' - 0"	2' - 6"	10' - 0"	FIXED	ALUMINUM	PAINT	PER MANUFACTURER	CARDINAL 366 LOWe	TEMPERED	
W004	9' - 0"	9' - 0"	8' - 11"	DOOR SLIDER DOUBLE	ALUMINUM	PAINT	PER MANUFACTURER	CARDINAL 366 LOWe	TEMPERED	
W005	6' - 0"	9' - 0"	8' - 11"	DOOR SLIDER DOUBLE	ALUMINUM	PAINT	PER MANUFACTURER	CARDINAL 366 LOWe	TEMPERED	
W006	9' - 0"	9' - 0"	8' - 11"	DOOR SLIDER DOUBLE	ALUMINUM	PAINT	PER MANUFACTURER	CARDINAL 366 LOWe	TEMPERED	
W100	4' - 6"	2' - 6"	10' - 0"	FIXED	ALUMINUM	PAINT	PER MANUFACTURER	CARDINAL 366 LOWe		
W101	3' - 0"	5' - 0"	8' - 0"	FIXED	ALUMINUM	PAINT	PER MANUFACTURER	CARDINAL 366 LOWe		
W102	3' - 0"	2' - 0"	11' - 0"	FIXED	ALUMINUM	PAINT	PER MANUFACTURER	CARDINAL 366 LOWe		
W103	4' - 0"	2' - 0"	11' - 0"	FIXED	ALUMINUM	PAINT	PER MANUFACTURER	CARDINAL 366 LOWe		
W104	11' - 10"	7' - 11"	7' - 11"	DOOR SLIDER TRIPLE	ALUMINUM	PAINT	PER MANUFACTURER	CARDINAL 366 LOWe	TEMPERED	
W105	4' - 0"	6' - 0"	9' - 0"	CORNER WINDOW	ALUMINUM	PAINT	PER MANUFACTURER	CARDINAL 366 LOWe		
W106	5' - 0"	2' - 0"	9' - 0"	FIXED	ALUMINUM	PAINT	PER MANUFACTURER	CARDINAL 366 LOWe		
W107	3' - 0"	5' - 0"	15' - 0"	FIXED	ALUMINUM	PAINT	PER MANUFACTURER	CARDINAL 366 LOWe		
W112	7' - 10"	7' - 11"	7' - 11"	DOOR SLIDER DOUBLE	ALUMINUM	PAINT	PER MANUFACTURER	CARDINAL 366 LOWe	TEMPERED	

WINDOW GENERAL NOTES:

- EMERGENCY ESCAPE AND RESCUE OPENINGS SHALL MEET THE FOLLOWING REQUIREMENTS. SEE I.R.C. SECTION R310.
- A. BASEMENTS WITH HABITABLE SPACES SHALL HAVE AT LEAST ONE OPERABLE EMERGENCY ESCAPE AND RESCUE WINDOW OR DOOR OR ACCESS TO AN ADJOINING BEDROOM WITH AN EMERGENCY ESCAPE AND RESCUE WINDOW.
- ALL EMERGENCY OPENINGS SHALL HAVE A MINIMUM NET CLEAR OPENING AREA OF 5.7 SQUARE FEET THE MINIMUM NET CLEAR OPENING HEIGHT SHALL BE 24 INCHES. THE MINIMUM NET CLEAR OPENING WIDTH SHALL BE 20 INCHES. EMERGENCY OPENINGS SHALL BE OPERATIONAL FROM THE INSIDE OF THE ROOM WITHOUT THE USE OF KEYS OR TOOLS. EXCEPT GROUND FLOOR, NET CLEAR AREA OF 5.0

SQUARE FEET. R310.1.1 TO R310.1.4.

- WINDOW SHALL HAVE A SILL HEIGHT OF NOT MORE THAN 44 INCHES ABOVE THE FLOOR. OPENINGS WITH A FINISHED SILL HEIGHT BELOW THE ADJACENT GROUND ELEVATION SHALL BE PROVIDED WITH A WINDOW WELL. R310.2.2
- D. WINDOW WELLS REQUIRED FOR ESCAPE OR RESCUE SHALL HAVE HORIZONTAL DIMENSIONS THAT ALLOW THE DOOR OR WINDOW TO BE FULLY OPENED. THE HORIZONTAL DIMENSION FOR THE WINDOW WELL SHALL PROVIDE A MINIMUM NET CLEAR AREA OF 9 SQUARE FEET WITH A MINIMUM HORIZONTAL PROJECTION AND WIDTH OF 36 INCHES. R310.2.3
- WINDOW WELLS WITH A VERTICAL DEPTH GREATER THAN 44 INCHES BELOW THE ADJACENT GROUND LEVEL SHALL BE EQUIPPED WITH A PERMANENTLY AFFIXED LADDER OR STEPS USEABLE WITH THE WINDOW IN THE FULLY OPENED POSITION. LADDERS OR RUNGS SHALL HAVE AN INSIDE WIDTH OF AT LEAST 12 INCHES, SHALL PROJECT AT LEAST 3 INCHES FROM THE WALL AND SHALL BE SPACED NOT MORE THAN 18 INCHES ON CENTER VERTICALLY FOR THE FULL HEIGHT OF THE WINDOW WELL.
- BARS, GRILLS, COVERS, SCREENS, ETC. SHALL BE PERMITTED TO BE PLACED OVER THE EMERGENCY EGRESS OPENING WINDOW WELL PROVIDED THE NET CLEAR OPENING SIZE IS NOT COMPROMISED AND THAT SUCH DEVICES SHALL BE RELEASED OR REMOVABLE FROM THE INSIDE WITHOUT THE USE OF A KEY, TOOL OR FORCE GREATER THAN THAT WHICH IS REQUIRED FOR NORMAL OPERATION. R310.4
- SAFETY GLAZING SHALL BE INSTALLED IN HAZARDOUS LOCATIONS AND SHALL MEET THE FOLLOWING REQUIREMENTS. SEE I.R.C. SECTION R308. FOR EXCEPTIONS SEE I.R.C. R308.4.
 - A. EACH PANE OF GLASS INSTALLED IN HAZARDOUS LOCATIONS SHALL BE PERMANENTLY IDENTIFIED BY MANUFACTURER, DESIGNATING THE TYPE, THICKNESS, AND SAFETY GLAZING STANDARD. THE LABEL SHALL BE ACID ETCHED, SANDBLASTED, CERAMIC FIRED OR EMBOSSED ON GLASS AND BE VISIBLE WHEN THE UNIT IS GLAZED. FOR EXCEPTIONS SEE I.R.C. R308.1.
 - PROVIDE SAFETY GLAZING IN FIXED AND OPERABLE PANELS OF SWINGING, SLIDING AND BIFOLD DOORS (R308.4.1.). SAFETY GLAZING SHALL BE PROVIDED WHEN GLAZING IN AN INDIVIDUAL FIXED OR OPERABLE PANEL ADJACENT TO A DOOR WHERE THE BOTTOM EXPOSED EDGE OF THE GLAZING IS LESS THAN 60 INCHES ABOVE THE FLOOR OR WALKING SURFACE AND IS WITHIN 24 INCHES OF EITHER SIDE OF THE DOOR IN THE PLANE OF THE DOOR IN A CLOSED POSITION OR WHERE THE GLAZING IS ON A WALL PERPENDICULAR TO THE PLANE OF THE DOOR IN A CLOSED POSITION AND WITHIN 24 INCHES OF
 - THE HINGE SIDE OF AN IN-SWINGING DOOR. (I.R.C. R308.4.2) C. PROVIDE SAFETY GLAZING WHERE THE BOTTOM EXPOSED EDGE OF THE GLAZING IS LESS THAN 36 INCHES ABOVE THE PLANE OF THE ADJACENT WALKING SURFACE OF STAIRWAYS, LANDINGS BETWEEN FLIGHTS OF STAIRS AND RAMPS. (I.R.C. R308.4.6)
 - D. PROVIDE SAFETY GLAZING IN DOORS AND ENCLOSURES FOR HOT TUBS, WHIRLPOOLS, SAUNAS, STEAM ROOMS, BATHTUBS AND SHOWERS. GLAZING IN ANY PORTION OF A BUILDING WALL ENCLOSING THESE COMPARTMENTS WHERE THE BOTTOM EXPOSED EDGE OF THE GLAZING IS LESS THAN 60 INCHES ABOVE A STANDING OR WALKING SURFACE. (I.R.C. R308.4.5)
 - PROVIDE SAFETY GLAZING IN RAILINGS REGARDLESS OF AN AREA OR HEIGHT. (I.R.C. R308.4.4) PROVIDE SAFETY GLAZING IN WALLS AND FENCES ENCLOSING SWIMMING POOLS OR HOT TUBS WHERE THE BOTTOM EDGE OF THE POOL OR SPA GLASS IS LESS THAN 60 INCHES ABOVE THE
 - WALKING SURFACE. (I.R.C. R308.4.5) PROVIDE SAFETY GLAZING IN FIXED OR OPERABLE PANELS THAT MEETS ALL OF THE FOLLOWING FLOOR, TOP EDGE GREATER THAN 36 INCHES ABOVE FLOOR, AND WITHIN 36 INCHES OF WALKING SURFACE. (I.R.C. R308.4.3)
- THE GENERAL CONTRACTOR AND WINDOW SUPPLIER ARE RESPONSIBLE TO FIELD MEASURE ALL WINDOW OPENINGS AND PROVIDE SHOP DRAWINGS BEFORE MANUFACTURER. SHOP DRAWINGS SHALL BE PROVIDED FOR EACH BUILDING INDIVIDUALLY AND SHALL NOT BE COMBINED WITH ANY OTHER BUILDING.
- THE WINDOW SUPPLIER SHALL BE RESPONSIBLE TO VERIFY ALL EMERGENCY EGRESS, LIGHT AND VENTILATION, AND TEMPERED GLASS LOCATION REQUIREMENTS PRIOR TO EACH SUBMITTAL.
- THE GENERAL CONTRACTOR AND WINDOW SUPPLIER ARE RESPONSIBLE TO VERIFY THAT EACH OF THE ABOVE LISTED REQUIREMENTS HAVE BEEN MET AND NOTE ANY DISCREPANCIES ON SUBMITTAL
- REFER TO THE PROJECT SPECIFICATIONS FOR ADDITIONAL INFORMATION.

(1) WINDOW GROUP 1

3/8" = 1'-0"






800 N 6th St Wahpeton, North Dakota

VALVAERE - CABIN

Emily Schmidt David Hartung Glen Erickson Logan Prochnow Chloe Lawrence Mikaela Prochnow

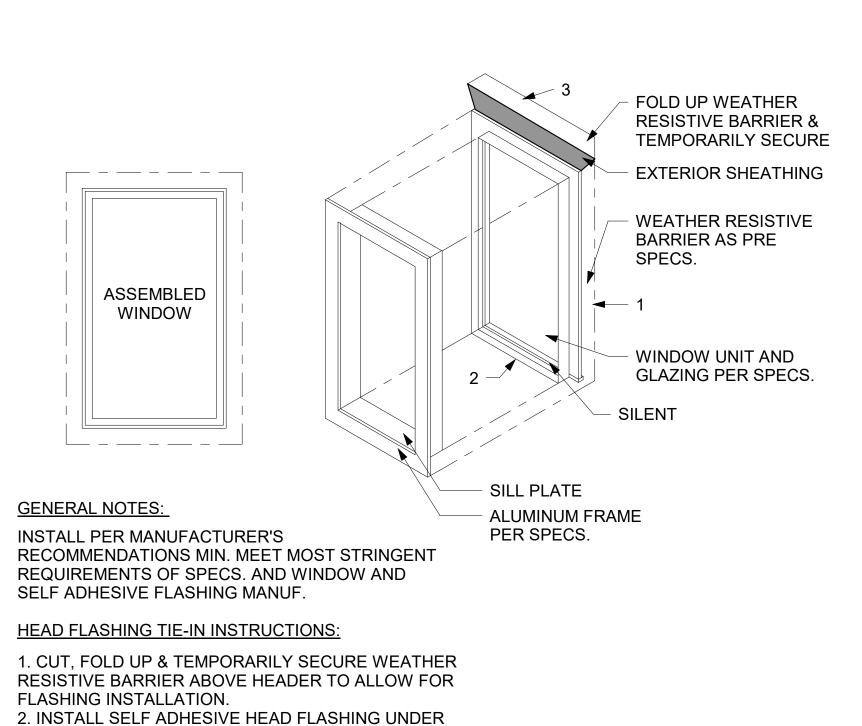


WEATHER RESISTIVE BARRIER

3 WINDOW FLASHING DETAIL 1/2" = 1'-0"

HEAD FLASHING AND SEAL WITH TAPE.

3. FOLD WEATHER RESISTIVE BARRIER BACK OVER

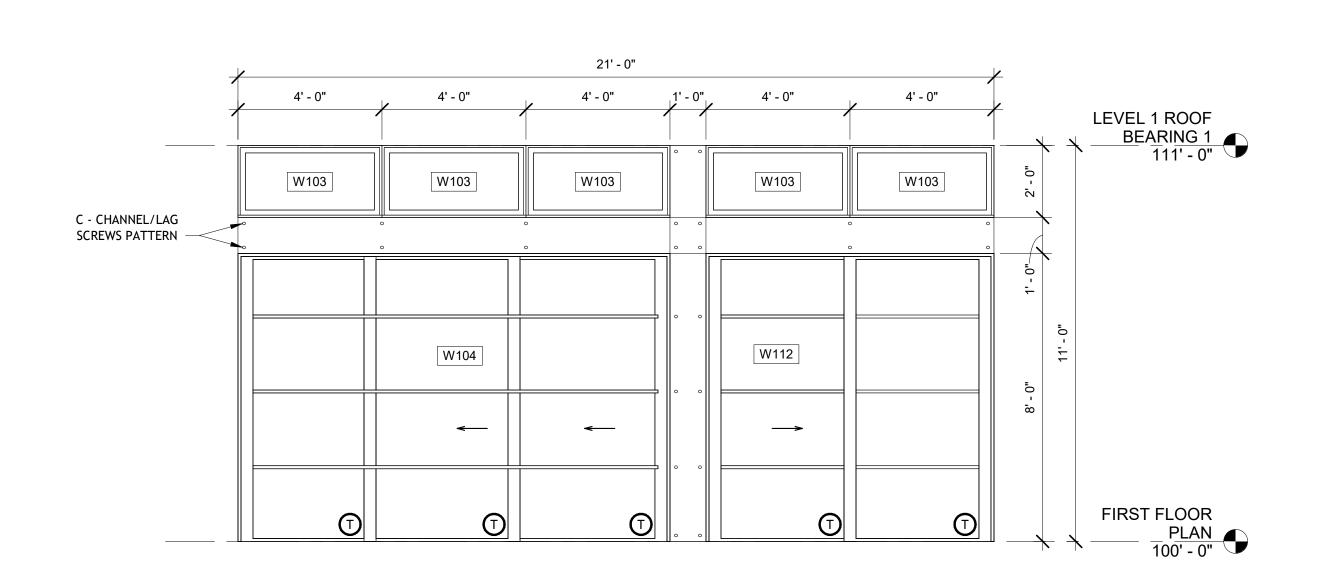

2 WINDOW GROUP 2 3/8" = 1'-0"

LEVEL 1 ROOF C - CHANNEL/LAG SCREWS PATTERN -W107 W107 BASELEVEL 0 -(T.O. ______

VALVAERE - CABIN


10226 N LIV PL, Park City, Utah


Lot C-07


WINDOW & DOOR SCHEDULE & **ELEVATIONS**


Project Number	20203284
Date	10/26/2023
Drawn By	EES
Checked By	DPH

Scale:

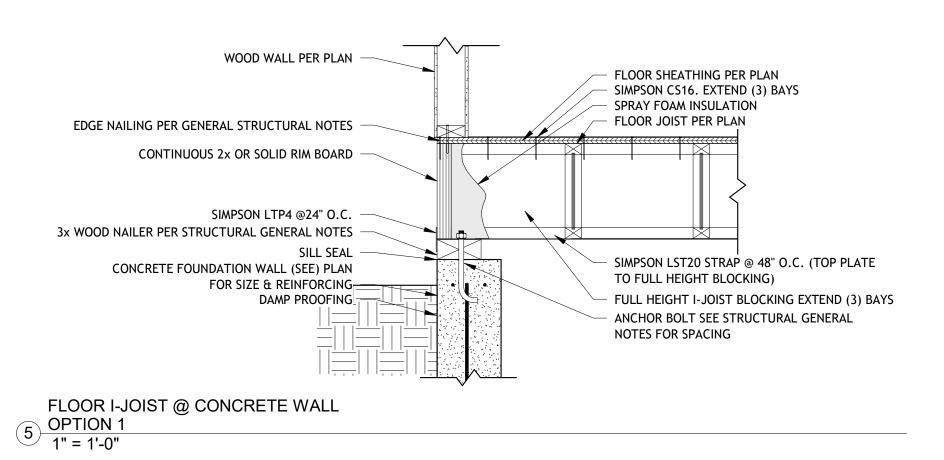

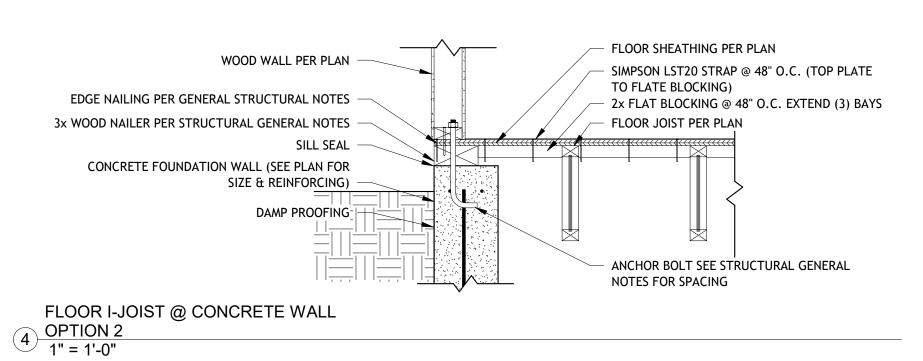

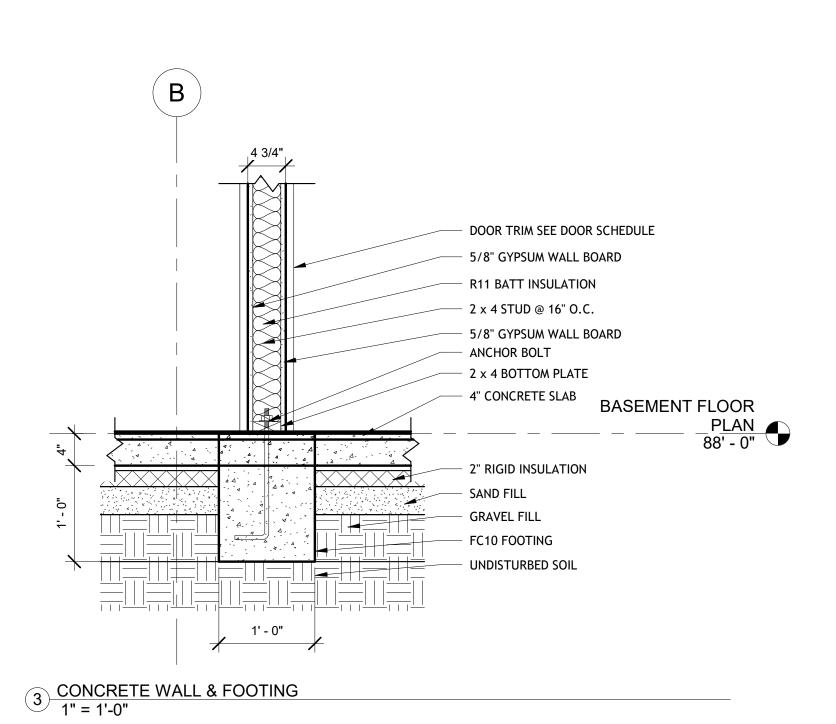

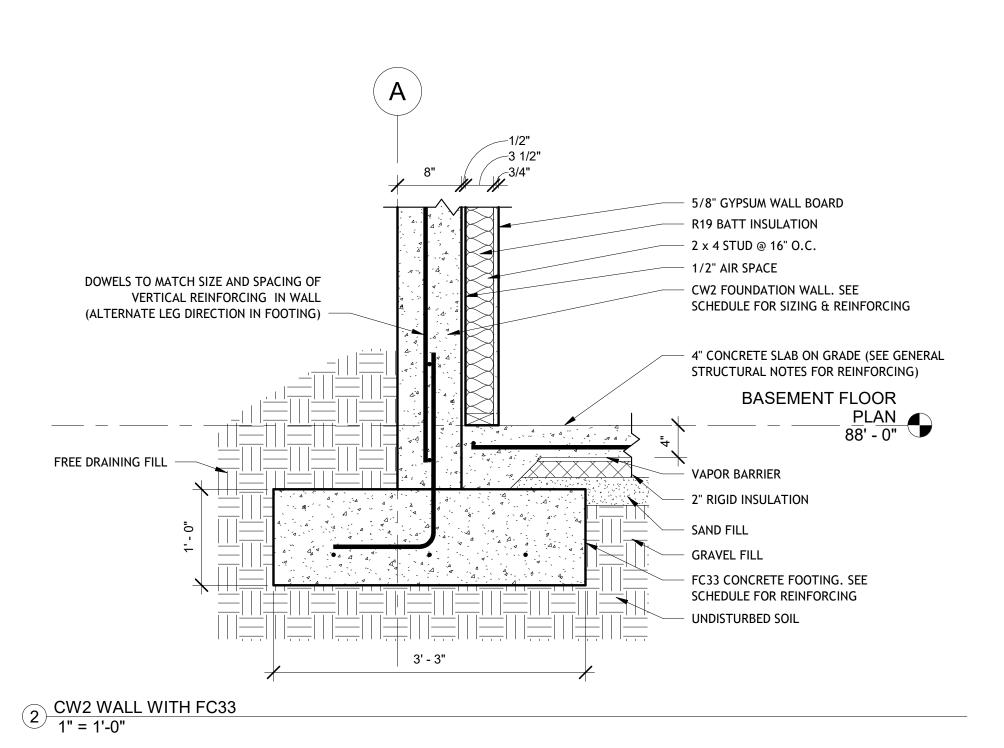

Mary Malina	Volumeta Tout
Key Value	Keynote Text
6106	CONCRETE PIER - PROVIDE 18"x18" WITH (1) #5 VERTICAL BAR AT EACH CORNER & (1) #5 VERTICAL BA AT EACH FACE OF THE PIER (8 VERTICAL TOTAL). PROVIDE #3 TIES @ 6" O.C. FULL HEIGHT OF PIER. PROVIDE (3) #3 TIES WITHIN THE TOP 5" OF THE CONCRETE PIER/COLUMN.
7101	PROVIDE 11"x11"x3/4" BASE PLATE wITH (4) 3/4" DIAMETER ANCHOR BOLTS INTO CONCRETE FOOTING/PIER. PROVIDE 7" EMBEDMENT INTO CONCRETE FOOTING/PIER/STEM WALL.
7102	PROVIDE 5-1/2"x11"x3/4" BASE PLATE WITH (2) 3/4" DIAMETER ANCHOR BOLTS INTO CONCRETE STEM/BASEMENT WALL. BASEPLATE AND COLUMN MAY BE EXTENDED DOWN TO THE TOP OF THE FOOTING IN ORDER TO AVOID CONFLICTS WITH DOOR OPENINGS. PROVIDE 7" EMBEDMENT INTO CONCRETE FOOTING/PIER/STEM WALL.
7105	PROVIDE 9"x9"x3/4" BASE PLATE WITH (4) 3/4" DIAMETER ANCHOR BOLTS INTO CONCRETE FOOTING/PIER. PROVIDE 7" EMBEDMENT INTO CONCRETE FOOTING/PIER/STEM WALL.
7116	PROVIDE 10"x16"x3/4" BASE PLATE WITH (4) 3/4" DIAMETER ANCHOR BOLTS INTO CONCRETE FOOTING/PIER. PROVIDE 7" EMBEDMENT INTO CONCRETE FOOTING/PIER/STEM WALL.
CG-03	STRUCTURAL BEAM- SEE STRUCTURAL DRAWINGS/BEAM TO BE PRIMED AND PAINTED AT ALL EXTERIOR LOCATIONS, PAINT COLOR AT ALL INTERIOR LOCATIONS PER INTERIOR DESIGN.
CG-10	STEEL PLATE AWNING.
CG-11	HEAVY TIMBER - SEE STRUCTURAL
CG-12	CEILING SOFFIT 4"WX6"H TO COVER STEEL BEAM
S-08	GUARDRAIL-36" MIN SEE DETAIL
S-09	STEEL BEAM, SEE STRUCTURAL-TO BE PRIMED AND PAINTED AT ALL EXTERIOR LOCATIONS-PAINT COLOR PER OWNER, PAINT COLOR AT ALL INTERIOR LOCATIONS PER INTERIOR DESIGN
S-12	HEAVY TIMBER, SEE STRUCTURAL
S-14	FIREPLACE, AS SELECTED BY OWNER, WALL FINISHES PER INTERIOR DESIGN- PROVIDE GAS HOOKUP PER MANUFACTURER'S INSTRUCTIONS
S-21	SEE ENLARGED STAIRS AND DETAILS ON SHEET A401 AND A402
S-24	ALL KITCHEN INTERIORS INCLUDING LIGHTING FIXTURES AND CASEWORK PER INTERIOR DESIGN
S-26	PROVIDE A U-FER GROUND. AN ELECTRODE ENCASED BY AT LEAST 2" OF CONCRETE-SHALL BE LOCATED NEAR THE BOTTOM OF THE CONCRETE FOUNDATION SYSTEM AND SHALL BE IN DIRECT CONTACT WITH THE EARTH, CONSISTING OF AT LEAST 20 FEET OF BARE ELECTRICALLY CONDUCTIVE ROD AT LEAST 1/2 INCH IN DIAMETER OR BARE COPPER CONDUCTOR NOT SMALLER THAN 4 AWG.(I.R.C.E3508.1.2 AND N.E.C.250.50)
S-28	CASEWORK PER INTERIOR DESIGNER
S-29	BATH TUB AS PER INTERIOR DESIGNER
S-30	VANITY AND PLUMBING FIXTURES PER INTERIOR DESIGNER
S-36	ELECTRICAL - MAIN ELECTRICAL PANEL WITH METER - INSTALLED AND COORDINATED AS REQUIRED I UTILITY PROVIDER- SEE ELECTRICAL PLANS
S-38	PROVIDE 100% SOLIDS EPOXY, HIGH PERFORMANCE COATING
S-40	CAVITY INSULATION PER SCHEDULE
S-41	STACKABLE WASHER/ DRYER. COORDINATE W/ INTERIOR DESIGNER & CONSTRUCTION TRADES AS REQUIRED
S-42	WALL MOUNTED SKI RACK
S-46	CONTRACTOR TO COORDINATE LOCATION OF PLUMBING FIXTURES WITH PLANS AND IN THE FIELD PRIOR TO POURING CONCRETE SLAB-SETTING BED TO PROVIDE SLOPE

1 B.O. FOOTING 1/4" = 1'-0"



CONCRETE WALL SCHEDULE								
MADIZ	MAIDTH	VERTICAL	HORIZONTAL	TOP & BOTTOM	NOTES			
MARK	WIDTH	REINFORCING	REINFORCING	BARS	NOTES			
CW-1	8"	<varies></varies>	#4 @ 12" O.C.	(2) #4 BARS	<varies></varies>			
CW-2	8"	<varies></varies>	#4 @ 12" O.C.	(2) #4 BARS	<varies></varies>			
CW-3	10"	<varies></varies>	#4 @ 12" O.C.	(2) #4 BARS	<varies></varies>			

	CONTINUOUS FOOTING SCHEDULE										
			LONGITUDINAL REINFORCING								
MARK	WIDTH	THICKNESS	NO.	SIZE	LENGTH	SPACEING					
FC10	1' - 0"	1' - 0"	2	#4	CONTINUOUS	EQUAL					
FC16	1' - 6"	1' - 0"	3	#4	CONTINUOUS	EQUAL					
FC33	3' - 3"	1' - 0"	5	#4	CONTINUOUS	EQUAL					

ISOLATED FOOTING SCHEDULE											
				CROSSWISE REINFORCING				LON	IGITUD	INAL REIN	FORCING
MARK	WIDTH	LENGTH	THICKNESS	NO.	SIZE	LENGTH	SPACING	NO.	SIZE	LENGTH	SPACING
FS20	2' - 0"	2' - 0"	<varies></varies>	3	#4	1'-6"	EQUAL	3	#4	1'-6"	EQUAL
FS26	2' - 6"	2' - 6"	1' - 0"	4	#4	2'-0"	EQUAL	4	#4	2'-0"	EQUAL
FS30	3' - 0"	3' - 0"	1' - 0"	5	#4	2'-6"	EQUAL	5	#4	2'-6"	EQUAL
FS36	3' - 6"	3' - 6"	1' - 0"	5	#4	3'-0"	EQUAL	5	#4	3'-0"	EQUAL
FS40	4' - 0"	4' - 0"	1' - 0"	6	#4	3'-6"	EQUAL	6	#4	3'-6"	EQUAL
FS50	5' - 0"	5' - 0"	1' - 0"	7	#4	4'-6"	EQUAL	7	#4	4'-6"	EQUAL

CONTRACTORS "SOARING ABOVE YOUR EXPECTATIONS"

FOOTING AND FOUNDATION PLAN NOTES:

1. VERIFY ALL DIMENSIONS WITH ARCHITECT PRIOR TO START OF CONSTRUCTION. 2. VERIFY LOCATIONS OF ALL INSERTS IN SLAB WITH THE ARCHITECTURAL, MECHANICAL, PLUMBING, AND ELECTRICAL PLANS PRIOR TO THE PLACEMENT OF CONCRETE SLAB.

3. CONCRETE SLAB ON GRADE SHALL BE 4" THICK OVER 2" SAND OVER 10 MIL. VISQUEEN (VAPOR BARRIER) OVER 4" TYPE II AGGREGATE BASE MATERIAL. AS AN OPTION, 10 MIL VISQUEEN MAY BE PLACE BELOW THE TYPE II AND THE SAND ELIMINATED. THE BASE MATERIAL SHALL BE MOISTENED (BUT NOT SATURATED) PRIOR TO THE PLACEMENT OF THE CONCRETE. RECOMMENDED REINFORCEMENT OF THE CONCRETE SLAB SHOULD BE #3 BARS AT 18" O.C. EACH WAY (FOR IMPROVED CRACK CONTROL RESULTS, EVERY OTHER BAR SHOULD BE CUT AT CONTROL JOINTS). AS AN ALTERNATE, 6 X 6 - W2.1 X W2.1 WELDED WIRE FABRIC (IN SHEETS), CENTERED IN SLAB THICKNESS.

4. ANCHOR BOLTS AND HOLDDOWNS SHALL BE SECURED IN PLACE PRIOR TO THE PLACEMENT OF CONCRETE, AND SHALL BE INSTALLED PER THE MANUFACTURER'S SPECIFICATIONS AND THE GENERAL NOTES. 5. ALL SITE WALLS, SIDEWALKS, OR OTHER ARCHITECTURAL FEATURES SHALL BE BY OTHERS (UNLESS NOTED

OTHERWISE). 6. THE FINISHED SURFACE OF THE SLAB ON GRADE SHALL BE NOTED AS 100'-0" (ELEVATION) UNLESS NOTED

OTHERWISE ON THE FOOTING AND FOUNDATION PLAN. 7. SIZE AND REINFORCEMENT OF ISOLATED AND CONTINUOUS FOOTINGS SHALL BE PER THE FOOTING SCHEDULE BELOW.

8. ALL EXTERIOR FOOTINGS SHALL BEAR BELOW FROST DEPTH (42") ACCORDING TO THE SOILS REPORT OR

APPLICABLE BUILDING CODES.



Wahpeton, North Dakota

VALVAERE - CABIN

Emily Schmidt David Hartung Glen Erickson Logan Prochnow Chloe Lawrence Mikaela Prochnow

VALVAERE - CABIN


10226 N LIV PL, Park City, Utah Lot C-07

FOUNDATION PLAN & DETAILS

Project Number	20203284
Date	10/26/2023
Drawn By	DPH
Checked By	EES

S 201

As indicated

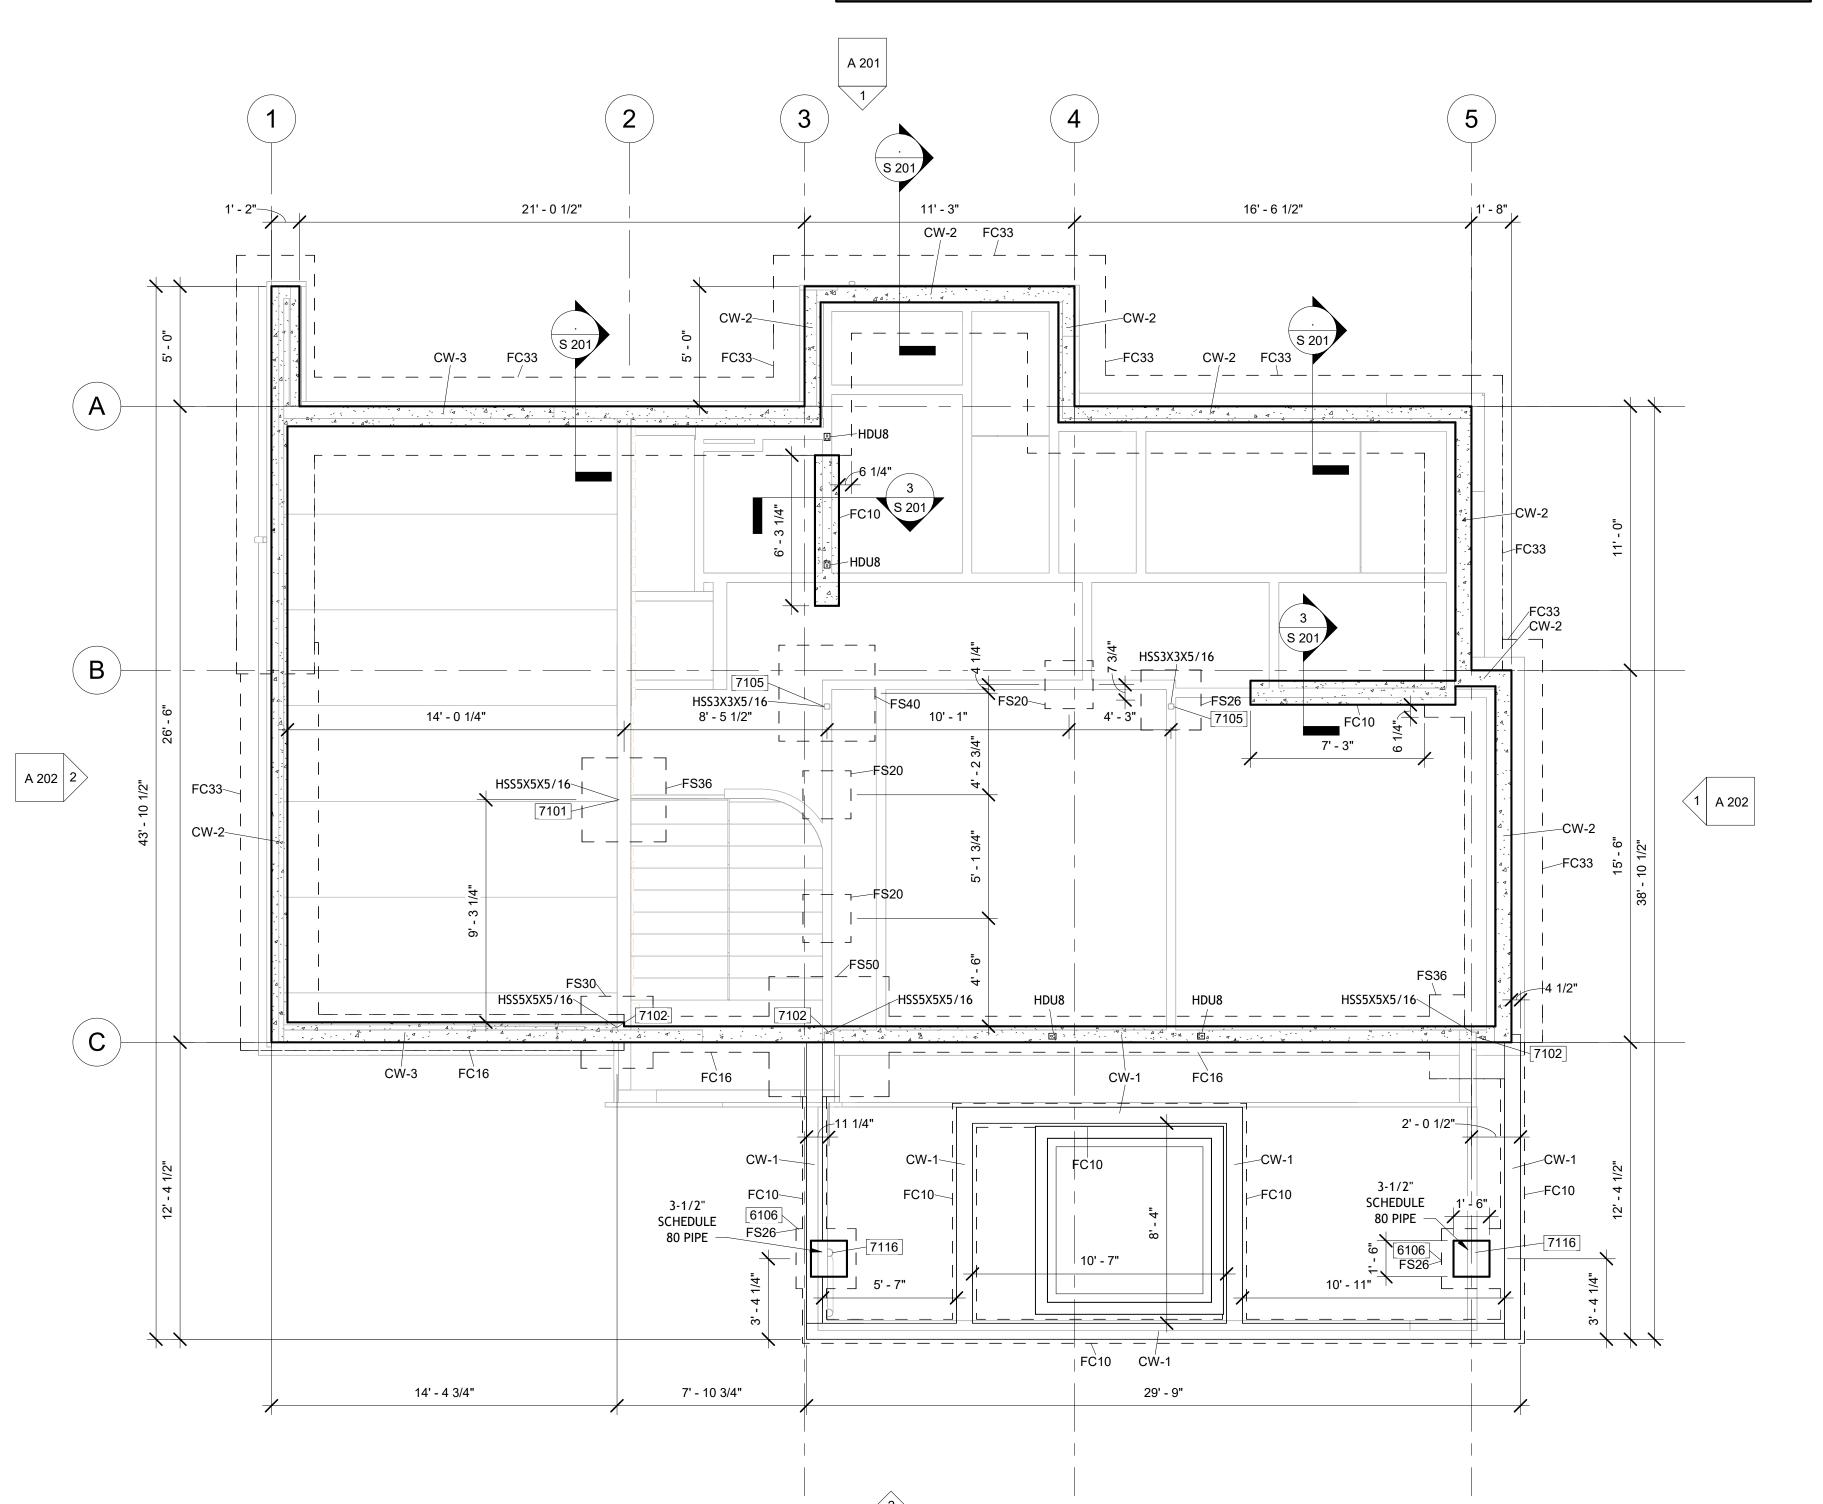

A 201



"SOARING ABOVE YOUR EXPECTATIONS"

ESTIMATE

Total:

\$1,190,045.00

OUR LABOR NUMBERS ARE BASED OFF THE 2021 EDITION OF GUIDE TO CONSTRUCTION COSTS.

WE CONVERTED THIS TO THE 2023 COST USING A 117% ON OUR NUMBERS





Materials & labor Estimate

		Takeoff Qty	Unit Cost	Amount
Item	Description	Quantity UOM	Cost/Unit UOM	Total
02-00	SITE WORK			
02-0203	Stake Building	1,325 SF	0.60 /SF	7!
02-0213	SWPPP Plan BMP	247 LF	3.89 /LF	9
02-0214	Lot Clearing	4,484 SF	3.98 /SF	\$17,846.
02-0220	Excavation	772 CY	5.14 /CY	\$3,961.
02-0221	Rough Grade	4,484 SF	5.86 /SF	\$26,276.
02-0222	Interior Concrete Grading	1,325 SF	0.80 /SF	\$1,060.
02-0223	Exterior Concrete Grading	1,325 SF	0.80 /SF	\$1,060.
02-0224	Finish Grade	4,484 SF	13.96 /SF	\$62,610.
02-0225	Hauling	457 CY	13.29 /CY	\$6,072.
02-0230	Backfill & Compact	315 CY	234.23 /CY	\$73,704.
02-0232	Gas Lines	10 LF	14.63 /LF	\$146.
02-0233	Elec/Phone/T.V. Line	10 LF	17.48 /LF	\$174.
02-0234	Water Lines	10 LF	7.23 /LF	\$72.
02-0235	Sewer Lines	10 LF	7.31 /LF	\$73.
02-0237	Storm Water System	10 LF	7.31 /LF	\$73.
02-0238	Footing Drain	112 LF	4.58 /LF	\$512.
02-0239	Radon Systems	30 LF	7.30 /LF	\$219.
02-0245	Road Construction	200 SF	0.80 /SF	\$160.
02-0280	Landscaping	4,484 SF	0.53 /SF	\$2,383.
02-0285	Sprinkler Systems	4,484 SF	0.40 /SF	\$1,784.
	SITE WORK	SSF	/SSF	\$199,948.2
03-00	CONCRETE			
03-0310	Footings	257 LF	26.00 /LF	\$6,682.0
03-0320	Foundations	3,053 SF	22.00 /SF	\$67,166.
03-0321	Concrete Site Walls	0 SF	0.00 /SF	\$0.
03-0330	Flatwork Interior	2,808 SF	22.00 /SF	\$61,776.
03-0340	Decorative Exterior Concrete	520 SF	14.00 /SF	\$7,280.
03-0350	Concrete Pumps	4 EA	2,400.00 /EA	\$9,600.
03-0352	Gypcrete	4,145 SF	3.04 /SF	\$12,600.
03-0353	Spandeck/Suspended Slabs	1,495 SF	20.00 /SF	\$29,900.
03-0355	Concrete Cutting	34 LF	1.99 /LF	\$67.
03-0360	Concrete Disposal	2 MO	2,800.00 /MO	\$5,600.
	CONCRETE	СҮ	/CY	\$200,672.





CARPENTRY	GSF	/GSF	\$131,883.03	
Timber Framing - Material	3,715 BF	6.44 /BF	\$23,913.46	
Timber Framing - Labor	3,715 LF	6.62 /LF	\$24,600.73	
Cabinetry Hardware	46 LF	317.00 /LF	\$14,582.00	
Cabinetry	92 LF	206.65 /LF	\$19,011.80	
Deck Surface Material	220 SF	5.20 /SF	\$1,143.12	
Deck Surface Labor	220 SF	1.47 /SF	\$322.96	
Siding Material	5,879 SF	1.64 /SF	\$9,636.14	
Siding Labor	5,879 SF	3.09 /SF	\$18,165.93	
• • • • • • • • • • • • • • • • • • • •	292 SF	· · · · · · · · · · · · · · · · · · ·	\$750.44	
, ,	,	,	\$560.29	
. ,	,	·	\$1,294.02	
		· ·	\$9,146.13	
	,	<u> </u>	\$3,809.17	
	·	•	\$3,809.17	
	·	·	\$1,707.04	
	3 252 GSE	0.97 /GSE	\$3,154.44	
ED AS A 6"x1/2" BOLT				
METALS	GSF	/GSF	\$40,303.15	
Decorative Metal	0 SF	0.00 /SF	\$0.00	
Interior Railing	21 LF	330.00 /LF	\$6,930.00	
	100 LF	•	\$33,000.00	
Steel Connections	•	•	\$14.21	
Structural Steel	1.056 LBS	0.34 /LBS	\$358.94	
METALS				
MASONRY	GSF	/GSF	96,537	
<u> </u>	167 LF	· · · · · · · · · · · · · · · · · · ·	3,359	
•			92,525	
,			653	
Stone Masonry - Site Walls	0 SF	0.00 /SF	0	
	Structural Steel Steel Connections Exterior Railing Interior Railing Decorative Metal METALS ED AS A 6"x1/2" BOLT CARPENTRY Framing - Labor Framing - Material Framing - Trusses Pickup Framing Finish Carpentry - Labor Finish Carpentry - Material Detail Finish Carpentry - Labor Detail Finish Carpentry - Material Siding Labor Siding Material Deck Surface Labor Deck Surface Material Cabinetry Cabinetry Hardware Timber Framing - Labor	Stone Masonry - Site Walls0 SFInterior Stone Masonry36 SFExterior Stone Masonry5,102 SFMasonry Accents167 LFMASONRYGSFMETALSStructural Steel1,056 LBSSteel Connections2 LBSExterior Railing100 LFInterior Railing21 LFDecorative Metal0 SFMETALSED AS A 6"x1/2" BOLTCARPENTRYFraming - Labor3,252 GSFFraming - Material3,252 GSFFraming - Trusses4,859 SFPickup Framing103 GSFFinish Carpentry - Labor2,212 FSFFinish Carpentry - Material2,212 FSFDetail Finish Carpentry - Labor292 SFDetail Finish Carpentry - Material292 SFSiding Labor5,879 SFSiding Labor5,879 SFSiding Material5,879 SFDeck Surface Labor220 SFDeck Surface Labor220 SFDeck Surface Material220 SFCabinetry92 LFCabinetry Hardware46 LFTimber Framing - Labor3,715 LF	Stone Masonry - Site Walls 0 SF 0.00 /SF Interior Stone Masonry 36 SF 18.14 /SF Exterior Stone Masonry 5,102 SF 18.14 /SF Masonry Accents 167 LF 20.11 /LF MASONRY GSF /GSF METALS Structural Steel 1,056 LBS 0.34 /LBS Steel Connections 2 LBS 5.92 /LBS Steel Connections 2 LBS 5.92 /LBS Steel Connections 2 LBS 5.92 /LBS Steel Connections 3 LBS 5.92 /LBS Steel Connections 2 LBS 5.92 /LBS Steel Connections 3.00 /LF Steel Connections 0.34 /LBS Steel Connections 0.97 /GSF Steel Connection 0.97 /GSF <th colsp<="" td=""></th>	

^{*} NUMBERS MAY BE HIGHER DUE TO ADDED STUDS FOR THE DOORS, WINDOWS, WINDOWS, CORNERS AND INTERSECTING PARTITIONS





07-00	THERMAL & MOISTURE			
07-0700	Dampproofing	6,473 SF	0.85 /SF	5,483
07-0710	Exterior Vapor Barrier	14,269 SF	0.05 /SF	769
07-0711	Rain Screen	14,269 SF	0.32 /SF	4,505
07-0720	Insulation	3,962 GSF	0.72 /GSF	2,837
07-0721	Air Sealing	3,962 GSF	0.10 /GSF	396
07-0725	Exterior Continious Insulation	12,326 SF	0.84 /SF	10,342
07-0730	Roofing	8,865 SF	2.31 /SF	20,478
* 07-0731	Roof Vents / Cupola / Finial	56 SF	1.59 /SF	89
07-0735	Metal Siding	5,830 SF	5.32 /SF	31,026
07-0740	Metal Flashing/Reglets	988 LF	6.79 /LF	6,708
07-0760	Gutters & Downspouts	150 LF	2.42 /LF	363
07-0761	Snow Retention	200 LF	32.00 /LF	6,400
07-0770	Fascia - Labor	185 LF	2.94 /LF	543
07-0771	Fascia - Material	185 LF	0.83 /LF	154
07-0772	Soffit - Labor	185 SF	4.81 /SF	889
07-0773	Soffit - Material	185 SF	0.68 /SF	\$124.99
	THERMAL & MOISTURE	GSF	/GSF	\$91,106.59
* 24 GAUG	GE 1 PIECE COUNTERFLASHING			

	08-00	DOORS & WINDOWS			
	08-0805	Interior Doors	19 EA	1,200.00 /EA	\$22,800.00
	08-0806	Door and Hardware - Install	4 EA	73.87 /EA	\$295.48
	08-0810	Exterior Doors	9 EA	4,675.25 /EA	\$42,077.25
	08-0815	Entry Door Systems	2 EA	500.00 /EA	\$1,000.00
*	08-0820	Door Hardware	26 EA	676 /EA	\$17,576.00
*	08-0825	Specialty Hardware	1 EA	1,000.00 /EA	\$1,000.00
*	08-0830	Garage Doors	Not Included In Estimate		
	08-0840	Windows	1,348 SF	30.63 /SF	\$41,289.24
*	08-0843	Specialty Windows/Doors	380 SF	47.36 /SF	\$17,989.70
*	08-0845	Window Install	15 EA	50.00 /EA	\$750.00
	08-0846	Window Flashings	691 LF	4.68 /LF	\$3,230.43
	08-0860	Mirrors	80 SF	7.00 /SF	\$560.00
	08-0870	Shower Doors	42 SF	24.60 /SF	\$1,033.07
		DOORS & WINDOWS	GSF	/GSF	\$149,601.17

^{*} Allowance for specialty hardware. In case client desires the thumb turn lock or key pad



^{*} Assuming that Tempered Glass and Glass sliding doors are specialty



09-00	INTERIOR FINISHES			
09-0920	Drywall	20,865 GSF	0.34 /GSF	\$7,156.70
09-0925	Specialty Drywall/Plaster	3,583 SF	0.17 /SF	\$613.05
09-0930	Tile Labor	5,059 SF	4.00 /SF	\$20,230.94
09-0931	Tile Material	5,059 SF	2.00 /SF	\$10,115.47
09-0938	Slab Tops	69 SF	85.00 /SF	\$5,865.00
09-0940	Hardwood Flooring	868 SF	6.68 /SF	\$5,802.23
09-0950	Carpet	460 SF	27.48 /SF	\$12,639.42
09-0957	Garage Coatings	356 SF	0.06 /SF	\$21.36
09-0960	Wall Coverings	0	0.00	\$0.00
* 09-0970	Interior Paint/Stain	25,141 GSF	0.80 /GSF	\$20,002.18
* 09-0975	Exterior Paint/Stain	6,602 GSF	0.80 /GSF	\$5,281.60
	INTERIOR FINISHES	GSF	/GSF	\$87,727.95

10-00	SPECIALTIES
11/-1/1/	SPECIALITES

* Number Includes taping and two layers of paint

10-1010	Sealed Combustion Fireplaces	2 EA	14,240.00 /EA	\$28,480.00
10-1013	Mantels/Surround	1 EA	2,200.00 /EA	\$2,200.00
10-1014	Hearths	2 EA	520.00 /EA	\$1,040.00
10-1015	Chimney Caps	2 EA	1,325.00 /EA	\$2,650.00
10-1030	Toilet/Bath Hardware	3 BA	18,000.00 /BA	\$54,000.00
10-1040	Master Closet Systems	8 LF	4.88 /LF	\$39.04
10-1045	Other Closet Systems	16 EA	4.88 /EA	\$78.08
10-1046	Garage Cabs/Storage	4 LF	387.39 /LF	\$1,549.55
	SPECIALTIES	GSF	/GSF	90,037





EQUIPMENT			
	9 EA	3,439.00 /EA	\$30,951.00
Custom Hoods	1 EA		\$1,099.00
Outdoor Appliances	3 LF	2,726.34 /LF	\$8,179.02
EQUIPMENT	GSF	/GSF	\$40,229.02
ELIDNICHINGS			
FURNISHINGS	Not Included In Estimate		
SPECIAL CONSTRUCTION			
Spas	1 EA		
SPECIAL CONSTRUCTION	GSF		
MECHANICAL WORK			
Plumbing Systems Allowance	1 EA	35,000.00 /EA	\$35,000.00
HVAC Systems Allowance	1 EA	27,000.00 /GSF	\$27,000.00
MECHANICAL WORK	GSF	/GSF	\$62,000.00
ELECTRICAL			
Electrical System Allowance	1 GSF	42,000.00 /GSF	\$42,000.00
ELECTRICAL	GSF	/GSF	\$42,000.00
	Appliances Custom Hoods Outdoor Appliances EQUIPMENT FURNISHINGS Furniture FURNISHINGS SPECIAL CONSTRUCTION Spas SPECIAL CONSTRUCTION MECHANICAL WORK Plumbing Systems Allowance HVAC Systems Allowance MECHANICAL WORK ELECTRICAL Electrical System Allowance	Appliances 9 EA Custom Hoods 1 EA Outdoor Appliances 3 LF EQUIPMENT GSF FURNISHINGS Furniture FURNISHINGS Not Included In Estimate SPECIAL CONSTRUCTION Spas 1 EA SPECIAL CONSTRUCTION GSF MECHANICAL WORK Plumbing Systems Allowance 1 EA HVAC Systems Allowance 1 EA MECHANICAL WORK GSF ELECTRICAL Electrical System Allowance 1 GSF	Appliances 9 EA 3,439.00 /EA Custom Hoods 1 EA 1,099.00 /EA Outdoor Appliances 3 LF 2,726.34 /LF EQUIPMENT GSF /GSF FURNISHINGS FURNISHINGS Not Included In Estimate SPECIAL CONSTRUCTION Spas 1 EA SPECIAL CONSTRUCTION GSF MECHANICAL WORK Plumbing Systems Allowance 1 EA 35,000.00 /EA HVAC Systems Allowance 1 EA 27,000.00 /GSF MECHANICAL WORK GSF /GSF LECTRICAL Electrical System Allowance 1 GSF 42,000.00 /GSF

Total

Total includes materials and limited Labor prices in sections 06-00 through 09-00. Permits and Preconstructions prices not included

Amount

\$1,190,044.83





Finish Materials Price Sheets

		Pow	der Room			
	Туре	Item #	Price	Found at	Location	Link
KOHLER, WHITE	TOLIET	K-5401-PA-0	\$ 4,518.75	Kohler		Smart Toilet with Bidet K-5401-PA KOHLER
STONE FOREST BLACK GRANITE CUSTOM INFINITY PEDESTAL SINK	SINK	C60D CG	\$ 6,350.00	Focal Point		<u>Sink - Powder Room</u>
KALLISTA	TOLIET PAPER HOLDER	P34408-00	\$ 340.00	Kallista		<u>Toliet Paper Holder</u>
KALLISTA	HOOK	P34407-00-BN	\$ 220.00	Kallista		<u>Hook</u>
KALLISTA	TOWEL BAR	P34401-00	\$ 500.00			<u>Towel Bar</u>

		Owner S	uite Bath			
	Туре	Item #	Price	Found at	Location	Link
KALLISTA	BATH FAUCET	P24405-LV	\$ 1,885.00	Shop GPS		<u>Faucet</u>
KALLISTA	BODY SPRAY	P22078-00	\$ 645.00	Kallista		Body Spray
KOHLER ANTHEM	SHOWER CONTROL UNIT	K-28214-CP	\$ 639.45	Build Ferguson		Shower Control Unit
KOHLER WHITE	WATERFALL SHOWER HEAD	K-76728GL-0	\$ 2,724.60	Kohler	Discontinued -similar item found	Real Rain - K-31110-0
KALLISTA	SHOWER ARM + HEAD	P24482-00	\$ 520.00	Kallista		Showerhead w/arm
KALLISTA	HAND SHOWER SET	P24843-00	\$ 535.00	Kallista		Shower Wand
KOHLER WHITE	TOLIET	K-30754-PA-0	\$ 8,625.00	Kohler		Smart Toilet
KOHLER WHITE	SINK	K-2330-0	\$ 464.77	Kohler		<u>Sink</u>
STUDIO LOHO EXTRA WHITE CLAY BATHTUB	BATHTUB		\$ 10,713.07			PDF -
KALLISTA	TUB SPOUT	P24414-00	\$ 595.00	Kallista		Tub Spout
	SINGLE CONTROL TRIM LEVER HANDLE	P24415-LV	\$ 1,045.00	Kallista		Handle/Control
KALLISTA	TOLIET PAPER HOLDER	P34408-00	\$ 340.00	Kallista		Toilet Paper Holder
KALLISTA	НООК	P34407-00-BN	\$ 220.00	Kallista		<u>Hook</u>
KALLISTA	TOWEL BAR	P34401-00	\$ 500.00	Kallista		<u>Towel Bar</u>

		Home Fi	nishes & Plans			
	Туре	Item #	Price	Found at	Location	Link
ROCKY MOUNTAIN HARDWARE	DOOR LEVER	E201 ROSE & L10302	\$ 1,037.00	Rocky Mountain Hardware	-	<u>Door Lever</u>
ROCKY MOUNTAIN HARDWARE	THUMB TURN	IP10150	\$ 286.00	Rocky Mountain Hardware	-	Thumb turn_
ROCKY MOUNTAIN HARDWARE	BUTT HINGE	HNG4B	\$ 130.00	Rocky Mountain Hardware	-	Butt Hinge
ROCKY MOUNTAIN HARDWARE	POCKET DOOR PULL	FP258	\$ 129.00	Rocky Mountain Hardware	-	Pocket Door Pull
ROCKY MOUNTAIN HARDWARE	APPLIANCE PULL	G10311 (CUSTOM SIZE)	\$ 317.00	Rocky Mountain Hardware	-	Appliance Pull
RAJACK	CABINET EDGE PULL	RJ758	\$ 50.00	RAJACK	DIRECT CALL	





			Laundry			
	Туре	Item #	Price	Found at	Location	Link
MAYTAG, WHITE	WASHER	MED8630HW	\$ 1,398.68	BUILD WITH FERGUS		<u>Washer</u>
MAYTAG, WHITE	DRYER	MHW8630HW	\$ 1,398.68	BUILD WITH FERGUS		MAYTAG DRYER

		Se	econdary Baths			
	Туре	Item #	Price	Found at	Location	Link
KALLISTA	BATH FAUCET	P22405-LV	\$ 1,885.0	OO Shop GPS		<u>Faucet</u>
KALLISTA	HAND SHOWER SET	P24843-00	\$ 575.0	00 KALLISTA		<u>Shower</u>
KALLISTA	SHOWER ARM	P24482-00	\$ 565.0	00 Kallista		Shower Head
KALLISTA	HEAD CONTROL	P24421-LV-CP	\$ 1,295.0	00 Kallista		Head Control
Kohler, white	TOLIET	K-5401-PA-0	\$ 4,518.	75 Kohler		<u>Toilet</u>
Kohler, white	SINK	K-2330-0	\$ 464.	77 Kohler		<u>Sink</u>
KALLISTA	TOLIET PAPER HOLDER	P34408-00	\$ 340.0	00 Kallista		<u>Toilet Paper Holder</u>
KALLISTA	HOOK	P34407-00-BN	\$ 220.0	00 Kallista		<u>Hook</u>
KALLISTA	TOWEL BAR	P34401-00	\$ 500.0	00 Kallista		<u>Towel Bar</u>

		Kit	chen			
	Туре	Item #	Price	Found at	Location	Link
KALLISTA	KITCHEN FAUCET	P25200-00-CP	\$ 1,526.25	Build Ferguson	BN	<u>Kitchen Faucet</u>
KOHLER STAINLESS STEEL	SINK	K-5540-NA	\$ 1,599.00	Build Ferguson		<u>Sink</u>
INSINKERATOR GRAY	DISPOSABLE	TEN-1706	\$ 308.00	Lowe's		<u>Disposable</u>
GAGGENAU STAINLESS STEEL	COOKTOP INDUCTION	C1282602	\$ 4,499.00	Designer Appliances		
ZEPHYR STAINLESS STEEL	HOOD	AK9228BS	\$ 1,099.00	Build Ferguson		<u>Kitchen Hood</u>
GAGGENAU STAINLESS STEEL	OVEN	480	\$ 7,699.00	Appliance Connection		<u>Kitchen Oven</u>
GAGGENAU STAINLESS STEEL	MICROWAVE	MW420620	\$ 1,999.00	Yudins Appliances		<u>Microwave</u>
GAGGENAU CUSTOM DOOR PANEL	DISHWASHER	DF211700	\$ 1,899.00	Designer Appliances		<u>Dishwasher</u>
GAGGENAU CUSTOM DOOR PANEL	FRIDGE	RY492705	\$ 12,499.00	Designer Appliances		Fridge - called for price
GAGGENAU CUSTOM PANEL	WINE/UNDERCOUNTER FRIDGE	T24UW905RP	\$ 3,599.00	AJ Madison		Panel Ready Fridge
GAGGENAU STAINLESS STEEL	COOKTOP GAS	CG280210CA	\$ 2,099.00	Appliance Connection		Gas Cooktop
ZEPHYR STAINLESS STEEL	HOOD	AK9228BS	\$ 1,149.00	Home Depot		Cooktop Hood







"SOARING ABOVE YOUR EXPECTATIONS"


SCHEDULE


OVER ALL - 230.9 DAYS (4/1/2024 - 2/17 25)
PRE - CONSTRUCTION - 4.5 DAYS
SITEWORK / CONCRETE - 60 DAYS
FRAMING - 98.95 DAYS
FINISHES - 67.5 DAYS




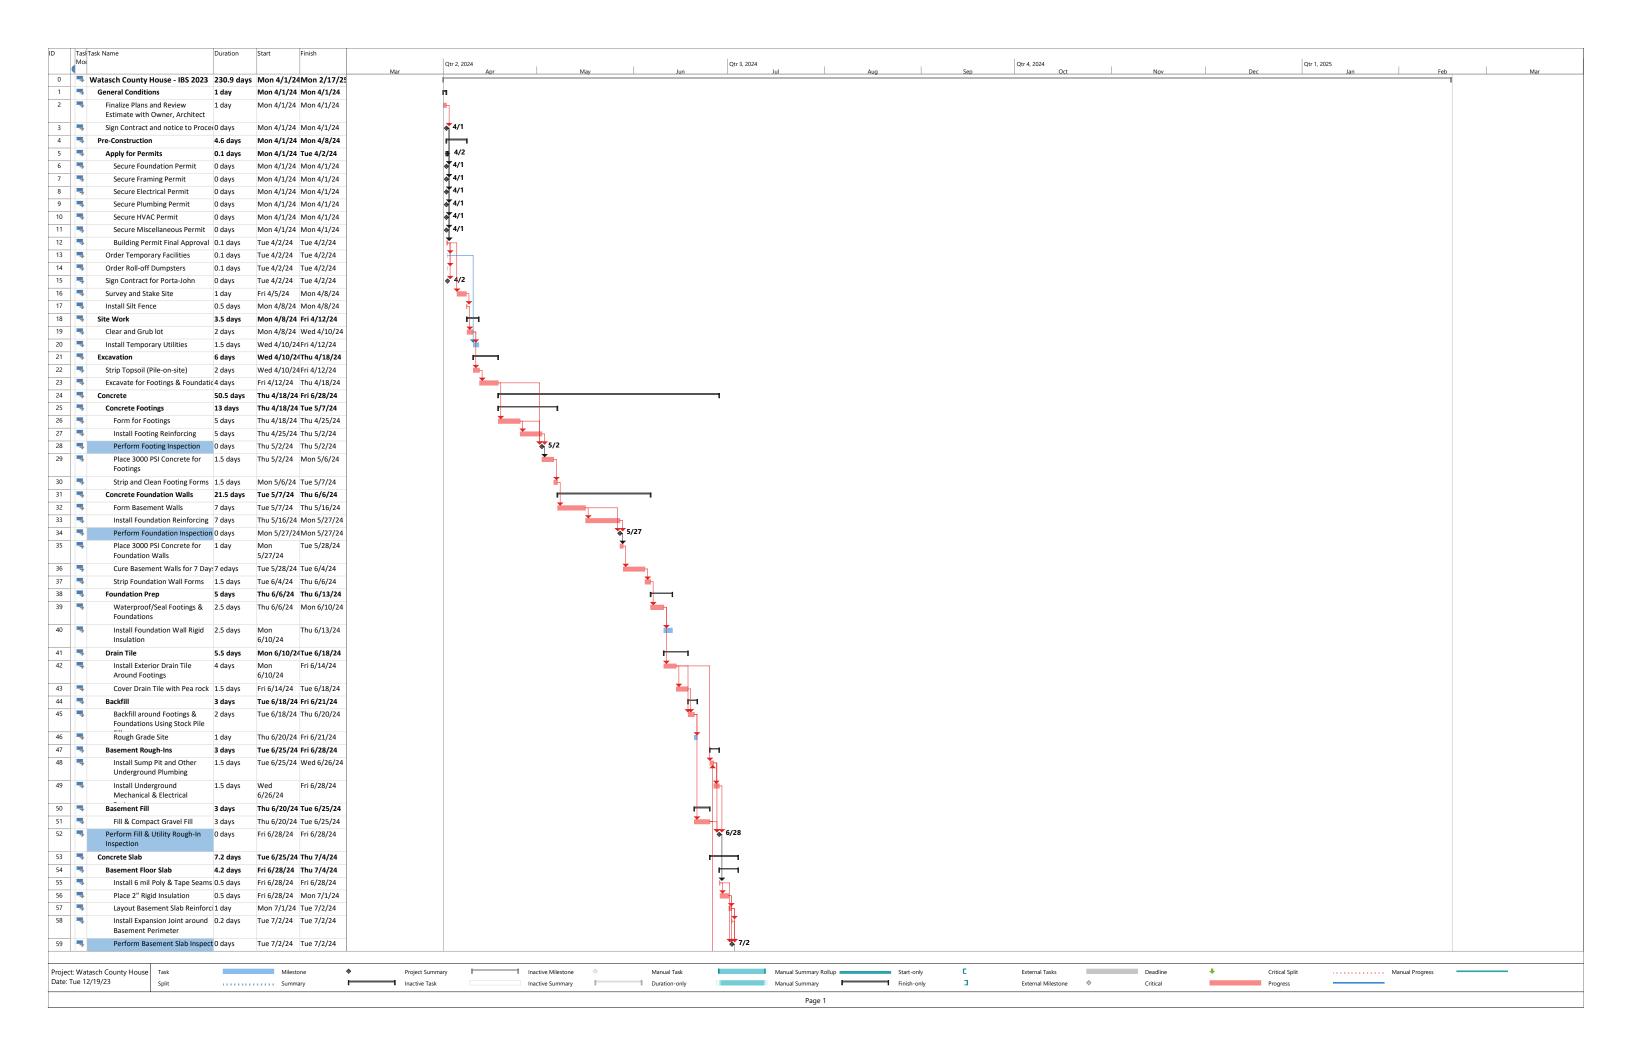

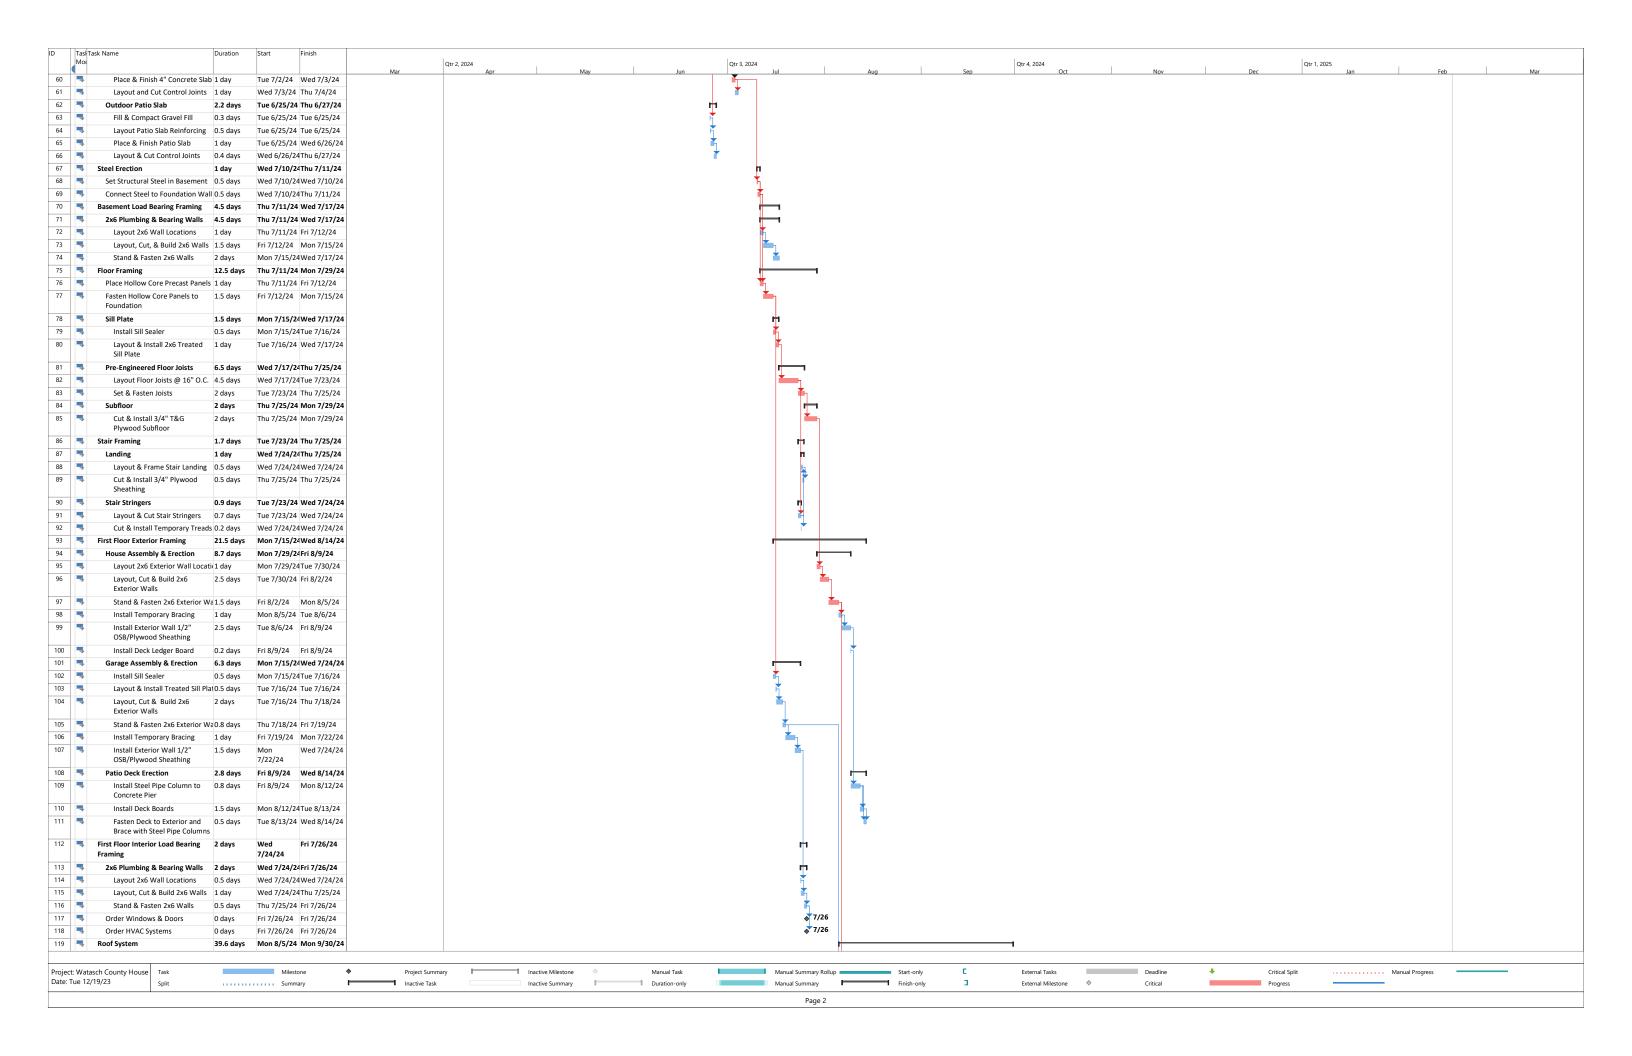

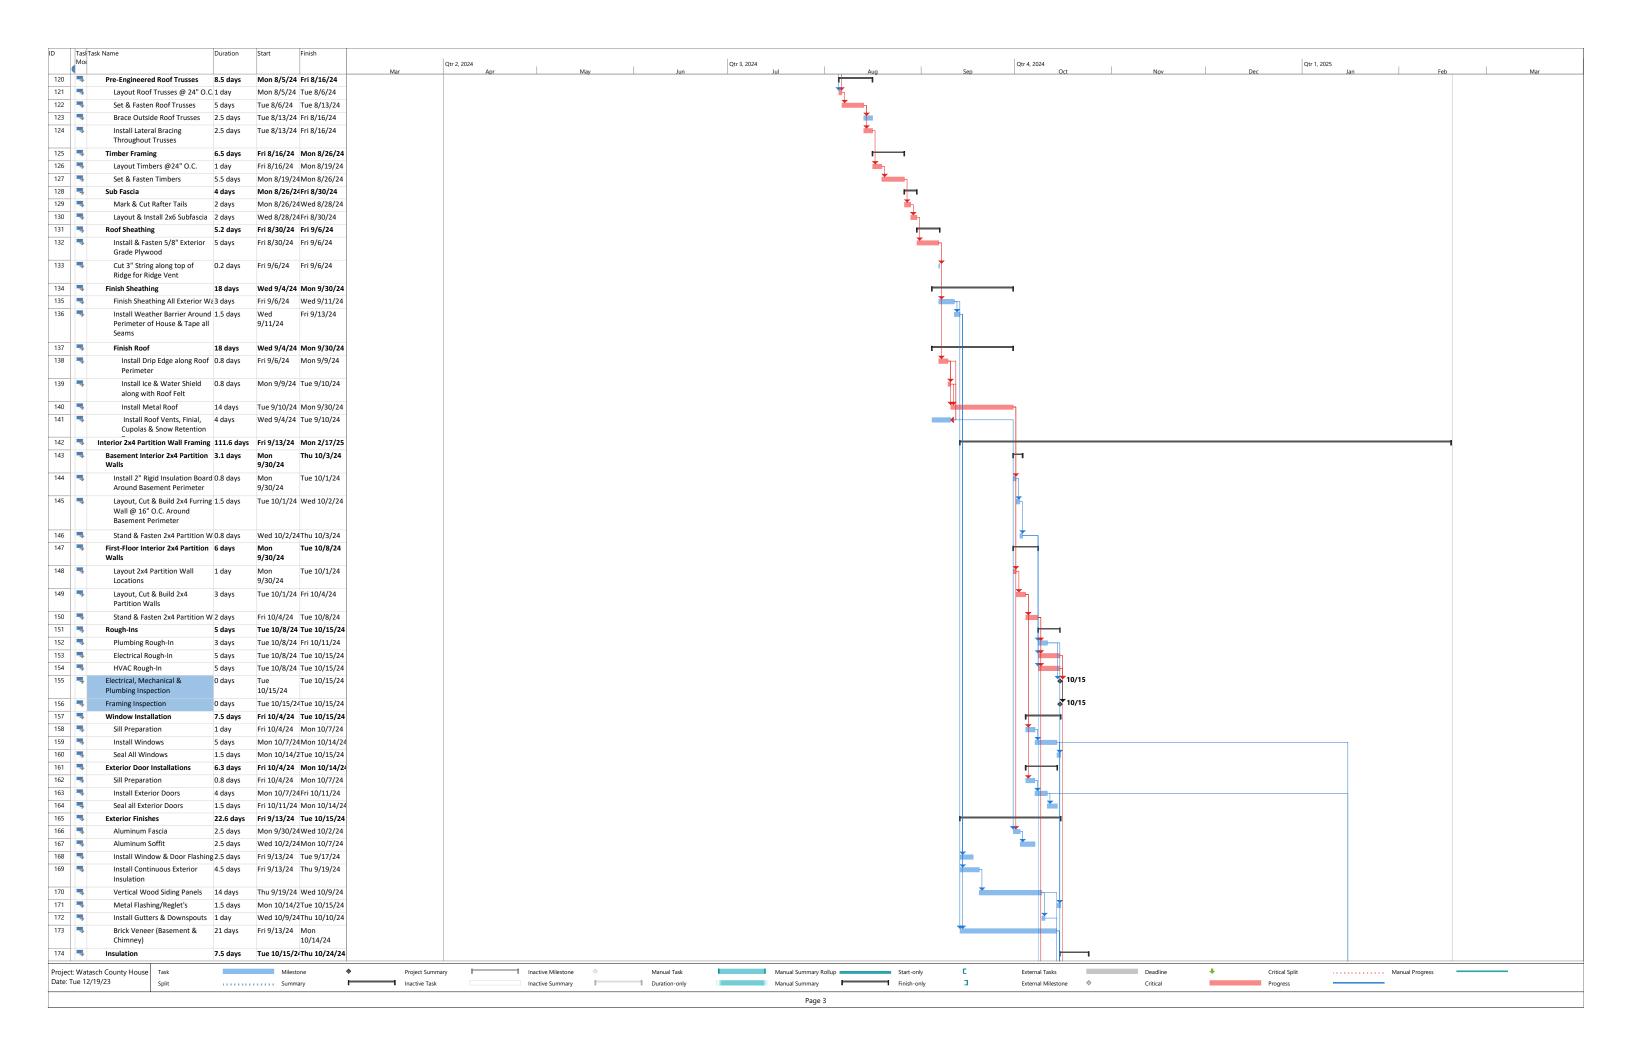

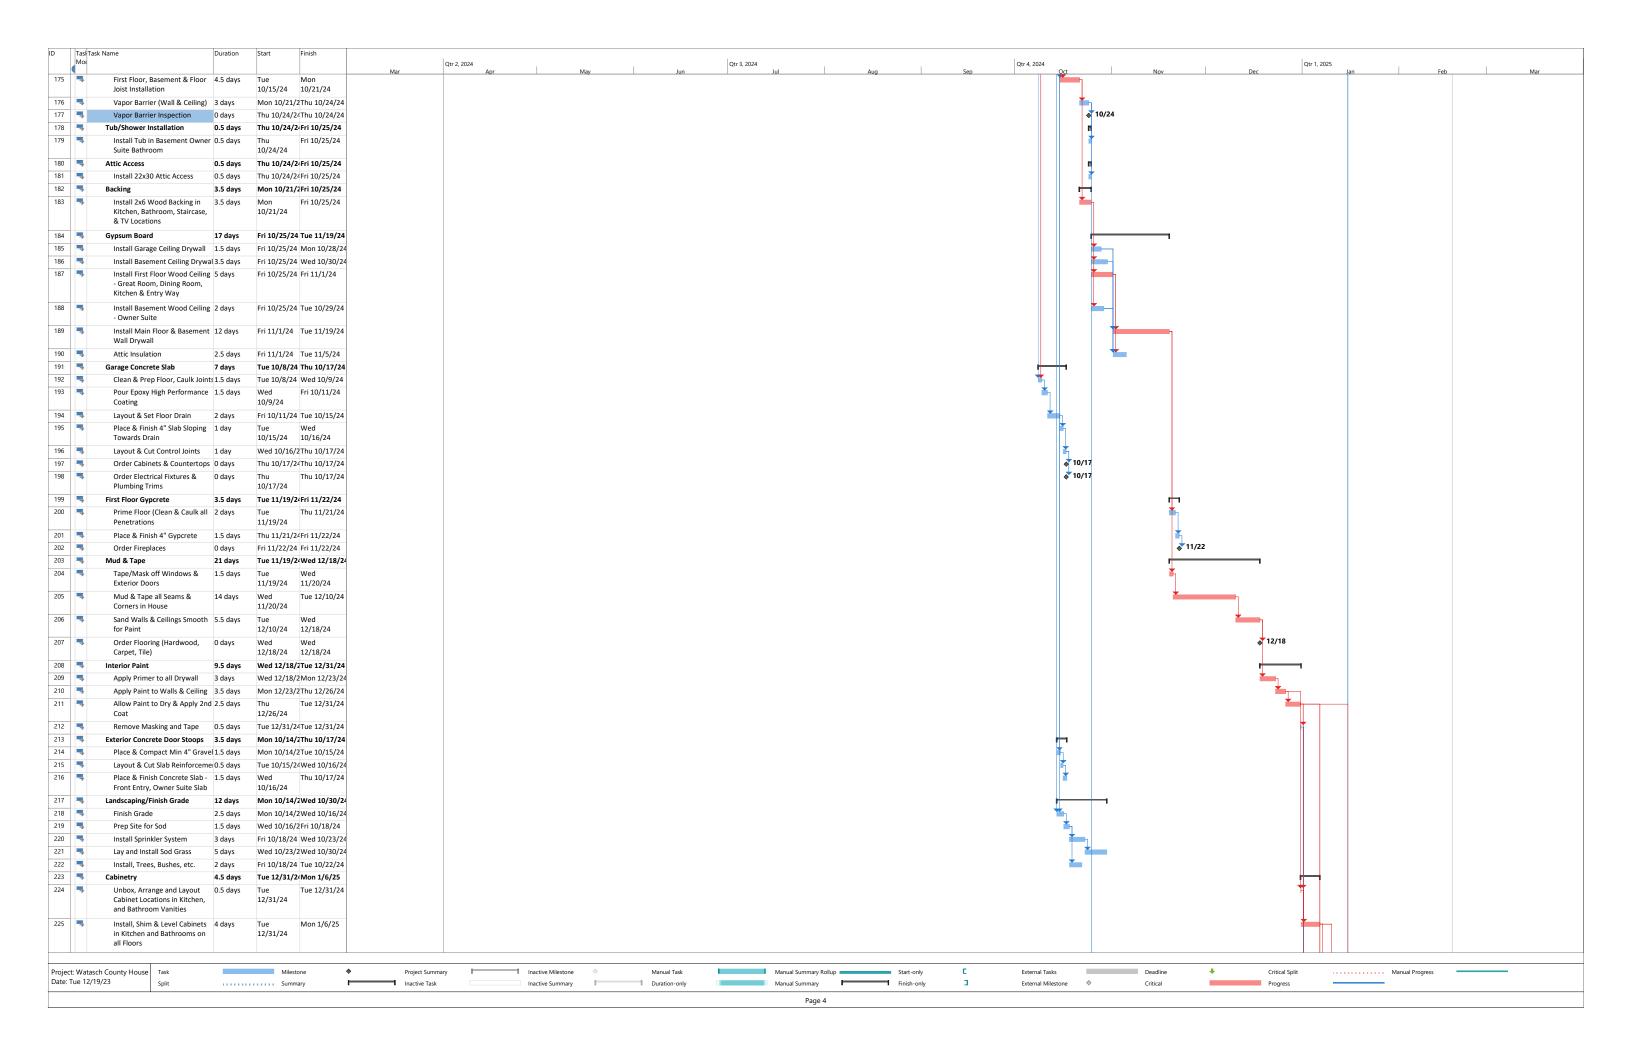

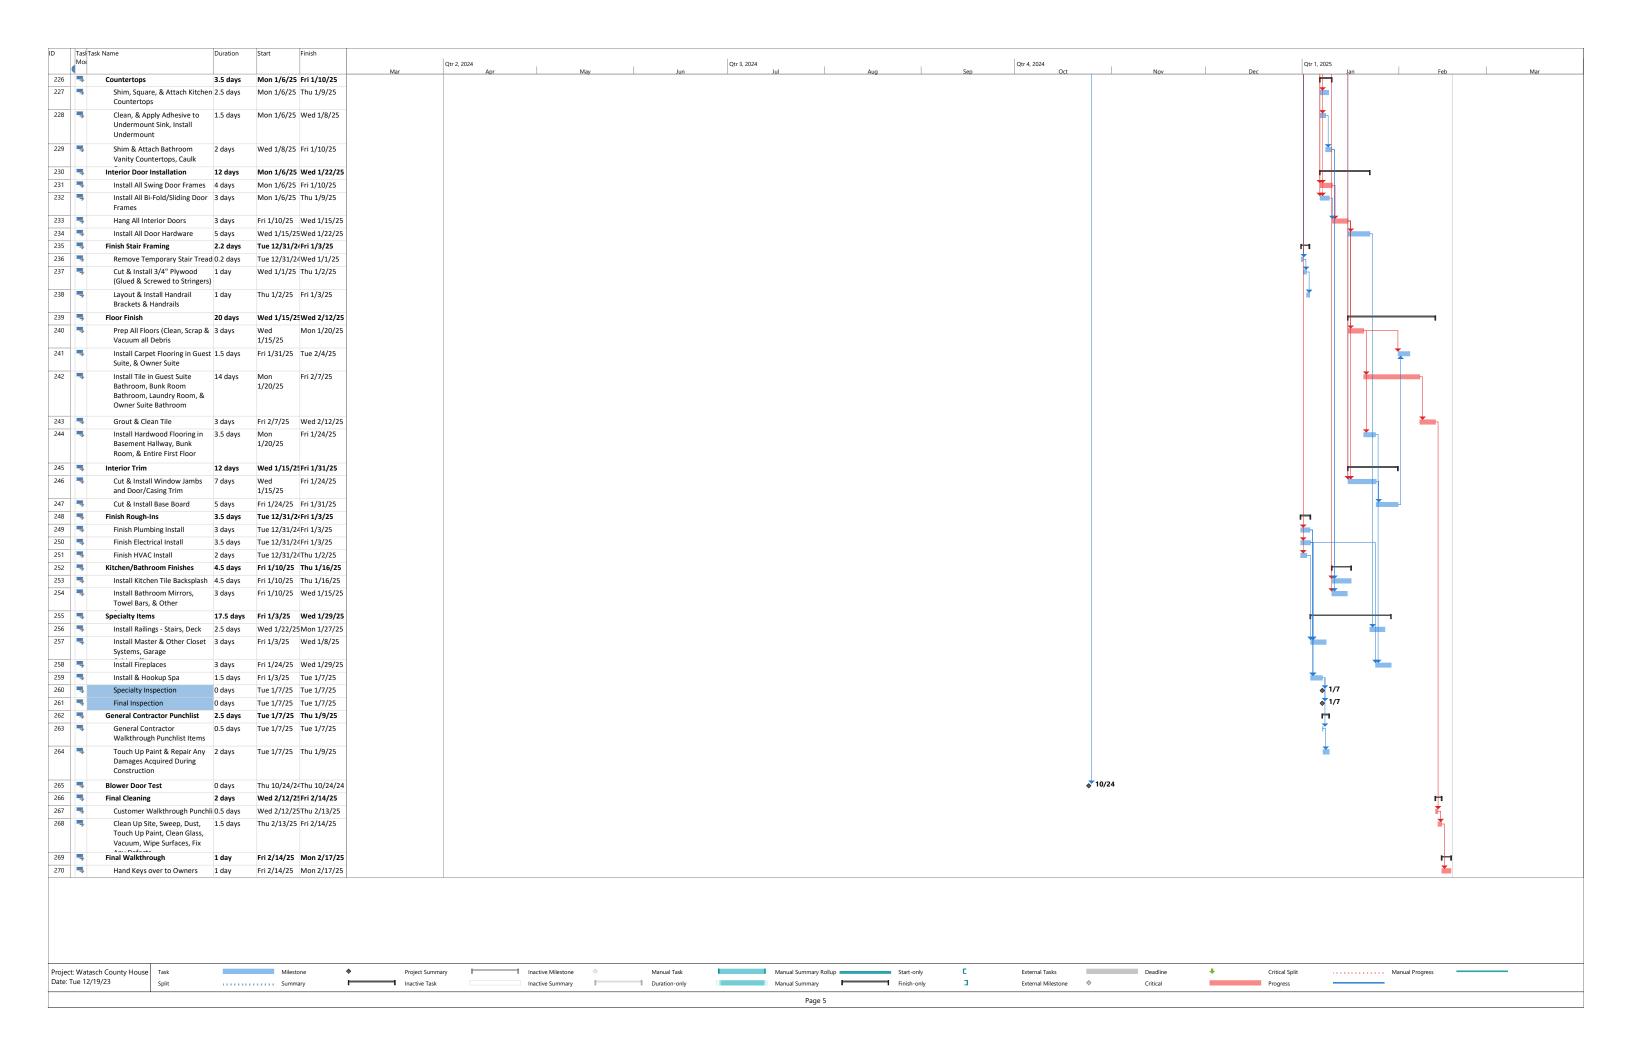



"SOARING ABOVE YOUR EXPECTATIONS"

MISCELLANEOUS





NAHB Student Competition Associate Degree Programs Honor Pledge

To the best of my knowledge and belief, the information used in my team's solution to the competition is in accordance with the rules and guidelines of the NAHB Student Competition. On my honor, I have neither given nor received unauthorized assistance in the completion of this project.

Print Name	Signature
Emily Schmidt	ENJERMIL
DAVID HARTUNG	Larit 96m
alen Erickson	Ille gige
Logan Prochnow	Lyon Puho
Mikaela Prochnow	WWall Protumow
Chioe Lawrence	Invel Jannence
CALLOR COMMARALLE	
aculty Advisor/Coach:	

This form is REQUIRED. Submit one (1) copy per team within your proposal submission.



APEX CONTRACTORS



General Information

Beds: 4 Bath: 3 1/2

House Size: 2,937 Year: 2024

Price: \$1,495,000 Garage: 2


Property Type: Stories:

SingleFamily

10226 N LIV PL, Park City, Utah



APEX CONTRACTORS

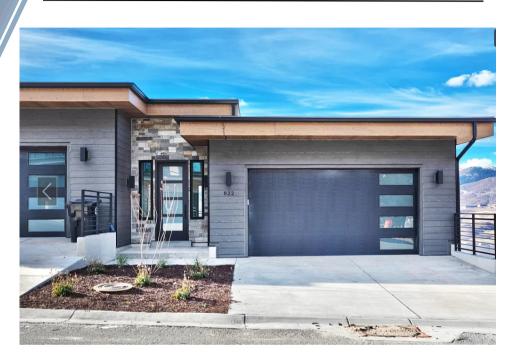

General Information

Beds: 3 Bath: 2 1/2

House Size: 2,747 Year: 2023

Price: \$1,425,000 Garage: 2

Property Type: Stories: Multi-Level

Residential, Townhouse

10226 N LIV PL, Park City, Utah





APEX CONTRACTORS



General Information

Beds: 4 Bath: 2 1/2

House Size: 2,559 Year: 2024

Price: \$1,094,890 Garage: 2

Property Type: Stories:

TownHouse

10226 N LIV PL, Park City, Utah

